ADDENDUM NO. 2

DATE: October 19, 2020

For

DRAWINGS, SPECIFICATIONS, PROPOSAL, CONTRACT AND BOND

For DYPSKI PARK IMPROVEMENTS CONTRACT NO. RP 17802R

FOR THE MAYOR AND CITY COUNCIL OF BALTIMORE

TO BIDDERS: THIS ADDENDUM IS HEREBY MADE A PART OF THE CONTRACT DOCUMENTS ON WHICH THE CONTRACT WILL BE BASED, AND IS ISSUED TO MODIFY, EXPLAIN AND/OR CORRECT THE ORIGINAL DRAWINGS AND SPECIFICATIONS. PLEASE ATTACH THIS ADDENDUM TO YOUR CONTRACT DOCUMENTS AND ACKNOWLEDGE IT ON THE BID OR PROPOSAL PAGE WHERE INDICATED.

APPROVED:

Adam Boarman, RLA

CHIEF OF CAPITAL DEVELOPMENT

DEPARTMENT OF RECREATION AND PARKS

Reginald Moore

DIRECTOR OF RECREATION AND PARKS

Acknowledgement: Acknowledge receipt of this addendum by inserting its number and date on your bid form. This addendum form is a part of the Contract Documents and modifies them as follows:

1. CHANGES TO THE SPECIFICATIONS:

| Item No. | SECTION No. | DESCRIPTION OF CHANGES |
|-----------|----------------------|---|
| .1 1 2 | 01 20 00 33 11 16 | DELETE page 44; REPLACE page 44r. DELETE page 413 to 414; REPLACE pages 413r to 414r. |

2. CHANGES TO DRAWINGS:

| Item No. | SHEET No. | DESCRIPTION OF CHANGES |
|----------|-----------------------|--|
| 2.1 | C1.1r (Vol # 1 dwgs.) | DELETE sheet C1.1 and REPLACE sheet C1.1r Proposed Utility Plan |
| 2.2 | C3.1r (Vol # 1 dwgs.) | DELETE sheet C3.1 and REPLACE sheet C3.1r Civil Details 1 |
| 2.3 | C3.2r (Vol # 1 dwgs.) | DELETE sheet C3.2 and REPLACE sheet C3.2r Civil Details 2 |
| 2.4 | L1.1r (Vol #2 dwgs.) | DELETE sheet L1.1 and REPLACE sheet L1.1r Pavilion Erection Roof Details |
| 2.5 | A1.0r (Vol #2 dwgs.) | DELETE sheet A1.0 and REPLACE sheet A1.0r Pavilion Erection Plans |
| 2.6 | A1.1r (Vol #2 dwgs.) | DELETE sheet A1.1 and REPLACE sheet A1.1r Pavilion Erection Plans |
| 2.7 | A1.2r (Vol #2 dwgs.) | DELETE sheet A1.2 and REPLACE sheet A1.2r Pavilion Erection Elevations |
| 2.8 | A3.1r (Vol #2 dwgs.) | DELETE sheet A3.1 and REPLACE sheet A3.1r Pavilion Erection Roof Details |
| 2.9 | A4.1r (Vol #2 dwgs.) | DELETE sheet A4.1 and REPLACE sheet A4.1r Comfort Station Improvements |

3. Responses to Request for Information / Clarification:

QUESTION 1: Is there any information that can be given on how the existing structure to be

relocated is going to be disassembled/reassembled?

ANSWER: Please refer to specifications Section 02 41 00- Selective Building Demoli-

tion, "Demolition Plan and Photographs-Pavilion" on sheet L1.1, and Demo-

lition Plan on sheet L1.0.

QUESTION 2: Are there any existing as-builts/details of how the existing structure to be relo-

cated was put together when it was initially built, so we can try to come up with

options on how it can be disassembled and reassembled?

ANSWER: There are no archived construction plans for the open-air pavilion (existing

structure).

QUESTION 3: Is it known what company constructed the original existing structure to be relo-

cated?

ANSWER: There are no archived construction records to identify the construction

company who constructed the original existing structure (open-air pavilion).

QUESTION 4: Is there any information available about how old this structure is and how many

times it has been moved and/or restored/improved?

ANSWER: Based on Baltimore City's Commission for Historical and Architectural

Preservation (CHAP), the existing open-air pavilion / structure is estimated to be built in 1873 based on Baltimore City's 1911 annual report and Baltimore Sun articles that included Joseph Newman paid and erected the market pavilion. When the Canton Market was closed in 1944, the majority of the pavilion was torn down, but this portion of the pavilion was saved and used as a recreational facility on O'Donnell St. until 1978, when it was moved to Dypski Park. The pavilion was relocated once, see attached "Baltimore City's 1911 annual report and Baltimore Sun articles that included Joseph Newman paid and erected the market pavilion was torn down, but this portion of the pavilion was saved and used as a recreational facility on O'Donnell St. until 1978, when it was

more Sun" article dated August 1978.

QUESTION 5: How much does the existing structure to be relocated weigh (approximately)?

ANSWER: Not known.

QUESTION 6: How long the trusses are on the existing structure to be relocated?

ANSWER: Approximately 60 ft.; contractor shall field verify this measurement.

QUESTION 7: Because of the existing structure to be relocated being a historical structure and

it being located where roads are tight - are there any restrictions or guidelines on how we disassemble, move, and reassemble the existing structure to be relo-

cated?

ANSWER: State of Maryland (and if required City of Baltimore) licensed demolition

contractor, transport company and reassemble contractor shall be selected with minimum years of experience and satisfy local, state and federal codes to dismantle, move and reassemble this existing structure. For further information, refer to the project's specification Section 02 41 00- Selective Building Demolition, "Demolition Plan and Photographs-Pavilion" on sheet

L1.1, and Demolition Plan on sheet L1.0.

QUESTION 8: Are we able to use the existing parking lot or part of the lot adjacent to the Dyp-

ski Park site for a staging area for equipment/materials and for use for the exist-

ing structure to be disassembled and relocated?

ANSWER: Construction access and staging area within the adjacent parking lot is

limited to where the limit of work (LOW) is shown on the demolition plan on

sheet L1.0 and grading plan on sheet L2.0.

QUESTION 9: What is the model number of the drinking fountain? Last time it was a HAWS

3380 FR EBONY PED. FOUNTAIN WITH HAWS 6518 FR IN GROUND PNEUMATC FR

VALVE SYSTEM FOR 3380. Is it the same, or has it changed?

ANSWER: See specification Section 33 11 16 Water Distribution, part 2.1 Materials, C.

QUESTION 10: Are approved equal alternates for the drinking fountain allowed? Haws has lim-

ited distributorship. Murdock was specified for the ground hydrant. And Mur-

dock makes drinking fountains?

ANSWER: Approved equals will be considered by the Engineer; however, Murdock's

fountains are not accepted by our department's Park Maintenance.

QUESTION 11: Will Miss Utility locate both locations or will we need to hire a private utility loca-

tor?

ANSWER: As per the project general notes item 4 on the coversheet on sheet CS.1 and

Section 01 76 04 Utilities located in Baltimore City's Standard Green Book (Department of Public Works Specifications for Materials, Highways, Bridges, Utilities and Incidental Structures, 2006", the contractor is responsible to locate and repair any existing utilities damaged during construction. The method and ways to locate the existing utilities shall be

determined and paid by the contractor.

QUESTION 12: Are there any restriction on work hours?

ANSWER: Working hours are Monday through Friday for 8 hour work days. For further

information, please refer to Section 01 14 00 Work Restrictions in Balti-

more City's Standard Green Book (Department of Public Works

Specifications for Materials, Highways, Bridges, Utilities and Incidental

Structures, 2006".

QUESTION 13: Column details show cap only; but, the building elevation illustrates a

base. Please provide details of base?

ANSWER: Base condition of columns is shown in detail A on sheet S-001.

QUESTION 14 Reviewing the pavilion column details on the manufacturer website, is the contract

drawing complete? Please provide welding details to join base casting to column

or base plate?

ANSWER: Base condition of columns is shown in detail A on sheet S-001.

QUESTION 15: What is the fall height for existing play equipment? and proposed swings?

ANSWER: 6-foot height for existing play equipment and 8-foot height for proposed

swings?

QUESTION 16: Clarify the symbol / item "E. Clerestory framing- see detail photo" in how it is asso-

ciated with any clerestory openings' improvements?

ANSWER: As with all portions of the existing structure, GC is to document the existing

and then provide shop drawings describing the intent for re-erection. Applied to the Clerestory, (part of the Existing Historic Structure) it is the exact same process. As per demolition drawings the metal panel covering added in the 1980's is to be demolished. Just like every other part of the existing historic structure, in the shop drawing submittal include framing

and details of the Clerestory.

QUESTION 17: Clarify the need for razing permit for the open air pavilion. There are construction

companies with the expertise and qualifications necessary to dissemble this struc-

ture.

ANSWER: A demolition/ razing permit will be needed for all the open air pavilion. This

permit will be attained by the contractor, for further information see

https://dhcd.baltimorecity.gov/sites/default/files/dhcd/attachments/Demoli-

tion%20Application%20Packet.pdf

QUESTION 18: The lump sum breakdown suggested in the specifications does not mention paint-

ing where should the cost be associated?

ANSWER: See page 60r, "Painting" has been added to schedule of values.

QUESTION 19: Note on S-301 states "All steel to be hot-dip galvanized and painted...." Does this

note apply only to the steel on page S-301, or is the City's intent to have all steel on the existing pavilion structure – including the salvaged cast iron column bearing struts, straps, boots, rods, and fasteners that make up the truss system removed from their current locations and treated in this manner? If this note only

applies to the steel on sheet S-301, is it referring only to the column cap modifications, or does it apply to the entirety of the new cast iron columns?

ANSWER:

The elements to be galvanized are the new steel plates only. After welding the plates are to be painted to match the column & existing components.

QUESTION 20:

The Note 18 on sheet S-001 states that all structural steel will be inspected on site by an independent 3rd party testing agency. Is the intent of this note to include the existing structural cast iron elements that hold the pavilion framing together? If so, must all cast iron fasteners and straps be fully removed for 3rd party inspection?

ANSWER:

The scope of inspection is to ensure connections & installation of components indicated in the structural drawings. The contractor is solely responsible for the disassembly and re-assembly of the existing pavilion structure beyond what is shown in the structural drawings. A 3rd Party Agency inspection is not required for the existing structural cast iron elements that hold the pavilion framing together. However, BCRP reserves the right to procure such an inspection at BCRP's cost

QUESTION 21:

The October 22, 2019 report by ECS confirms the presence of lead in the paint coatings of the pavilion structure. Please confirm that there is no intent to strip or remove the existing paint coatings from the pavilion framing elements, and that the project intent is to encapsulate the lead-containing coatings in the new paint layers.?

ANSWER:

Contractor to comply with all local, state and federal codes when dealing with lead based materials (includes paint). For only those work zone areas on the existing pavilion disturbed by work activities, the existing lead based materials (includes paint) shall be stripped and/or removed prior to proceeding with work; for example, work zone area may be the surface area required to cut a timber beam or the metal hardware connection to be loosened and/or removed. For those existing surfaces to not be disturbed by work activities, these existing lead painted surfaces can remain and be encapsulated with paint; for example, the remaining timber beam length not to be cut. Loose flaking lead paint shall be scraped and removed prior to repainting.

| 45. Electrical (excludes pavilion) |
|---|
| 46. Seed and Mulch |
| 47. Transport Pavilion to Gwynns Fall Leakin Park |
| 48. Pavilion Relocation Roofing |
| 49. Pavilion Relocation Carpentry |
| 50. Pavilion Relocation Columns |
| 51. Pavilion Relocation Cast-in-place concrete |
| 52. Pavilion Relocation Electrical |
| 53. ADA Restroom Electrical |
| 54. ADA Restroom Interior Improvements |
| 55. Painting |

In addition to the Schedule of Values required by Paragraph 2.01 of this Section, the Contractor shall submit a further breakdown of Item 3, 4, and 33 of the Schedule of Values.

Item 6 and 34 shall be subdivided into the costs for incremental installation of sediment control devices as required by the Sequence of Construction indicated on the Drawings. Payment under this breakdown will be limited to an initial payment of 50 percent of the value for devices installed for each increment of sediment control required for that Sequence of Construction at the first monthly estimate after satisfactory installation. The remaining 50 percent payment of the incremental sediment control devices will be made monthly for the duration those devices are required and properly maintained to the satisfaction of the Engineer.

2.3 Bid Item 201 – Earth Excavation and Gravel Refill Below Subgrade

- A. Measurement and Payment of this Item will be based on the calculated volume in cubic yards from field measurements between the subgrade shown on the Drawings and the measured depth and horizontal measurements of the directed excavation
- B. Payment for this item will be made at the unit price bid per cubic yard and will include all labor, material, and equipment necessary to satisfactorily excavate and backfill with furnished materials where directed by the Engineer. Gravel shall meet the requirements of CR-6 and methods of placing and compacting shall conform to the other applicable requirements of the Specifications.
- C. The lump sum price for this item shall include full compensation for all work shown on the Drawings as outlined in the Specifications with the exception of Bid Item 101.
- D. Bid item on Bid Forms will be reviewed, and accepted or rejected, at Owner's option. Accepted bid items will be identified in the Owner-Contractor Agreement.
- E. Coordinate related work and modify surrounding work the integrate the Work of each bid item/alternate.
- F. Partial payment for this item will be made on the basis of percentage complete of the construction categories listed in the SCHEDULE OF VALUES.

01 20 00 MEASUREMENT AND PAYMENT

33 11 16 WATER DISTRIBUTION

PART 1 – GENERAL

1.01 SECTION INCLUDES

- A. The work consists of furnishing and installation of all water pipes, drinking fountain, pipe fittings, water valves, and appurtenances at the locations as shown on the Contract Drawings and as directed by the Engineer. Included in this work is all excavation and backfill for trenches.
- B. All pipe shall be laid on a firm bed and properly backfilled.

1.02 RELATED SECTIONS

A. Section 33 11 13- City of Baltimore Department of Public works Specifications Materials, highways, Bridges, Utilities, and Incidental Structures, 2006; or latest edition (Standard Specifications).

1.03 SUBMITTALS

A. Submit shop drawings, catalog cuts and installation details for all items to the Engineer for approval.

PART 2 – PRODUCTS

2.01 MATERIALS

- A. Ductile Iron Pipe and Fittings: Refer to the Standard Specifications
- B. Copper Piping: Seamless Copper Water tube shall comply with ASTM B88, Type K, Soft with wrought copper solder joint fittings, 150 lb., ASA B16.3 and threaded pipe.
- C. Drinking Fountain: Haws Model No. 3380FR barrier free pedestal fountain with freezeresistant valve or approved equal, and all appurtenant materials for a complete operating system as manufactured by Haws Company (1-775-359-4712). Type 304 Stainless Steel satin finish bracket and 11 gauge Type 304 Stainless Steel satin finish basin with integral swirl design, polished chrome-plated brass vandal-resistant bubbler head, polished chrome-plated brass push-button, chrome-plated brass vandal-resistant waste strainer, vandal-resistant bottom plate, 3/16" (.47 cm) galvanized steel top-access pedestal with green powder-coated finish, integral mounting plate, and 1-1/4" IPS waste..

Finish: Ebony (Black) powder coat.

<u>WATER DISTRIBUTION</u>
<u>33 11 16-1</u>
-413r-

Quantity: One (1).

D. Valves and Appurtenances

- 1. Refer to Section 33 12 16 of the Standard Specifications.
- 2. All manufacturers' makes and models of valves, vaults, frames and covers must be on a list previously approved by Baltimore City Bureau of Water and Wastewater.
 - i. Haws Water Valve, Model 6518FR is a fully engineered pneumatic operated freeze-resistant valve system installed below frost line.
- E. Flush Box Hydrant: Murdock-Super Secur Model No. M-575, ³/₄" Freeze resistant, flush-mounted box hydrant with lock lid, as manufactured by Murdock Company (800-591-9880 or 626-333-2543).
- F. Concree: Mix No. 3, conforming to Section 03 30 00.

2.02 PRECAST STRUCTURES

- A. Valve Vaults as manufactured by Horne Concrete Construction, or Mayer Bros, Inc.
- B. Ring and Covers shall be bolted type.

PART 3 – EXECUTION

3.01 CODES


- A. Prior to starting plumbing work, Contractor to verify adequate water pressure at the water meter prior for combined existing and proposed water demand for the building and/or park property use.
- B. All plumbing work shall comply with the N.S.P.C. Plumbing Codes and the regulations of the Health Department of Baltimore City and the State of Maryland. Obtain all approvals before starting plumbing work.

3.02 WATER FIXTURES

A. Install equipment in accordance with manufacturer's instructions and Contract Drawings.

END OF SECTION 33 11 16

<u>WATER DISTRIBUTION</u>
<u>33 11 16-2</u>
<u>-414r-</u>

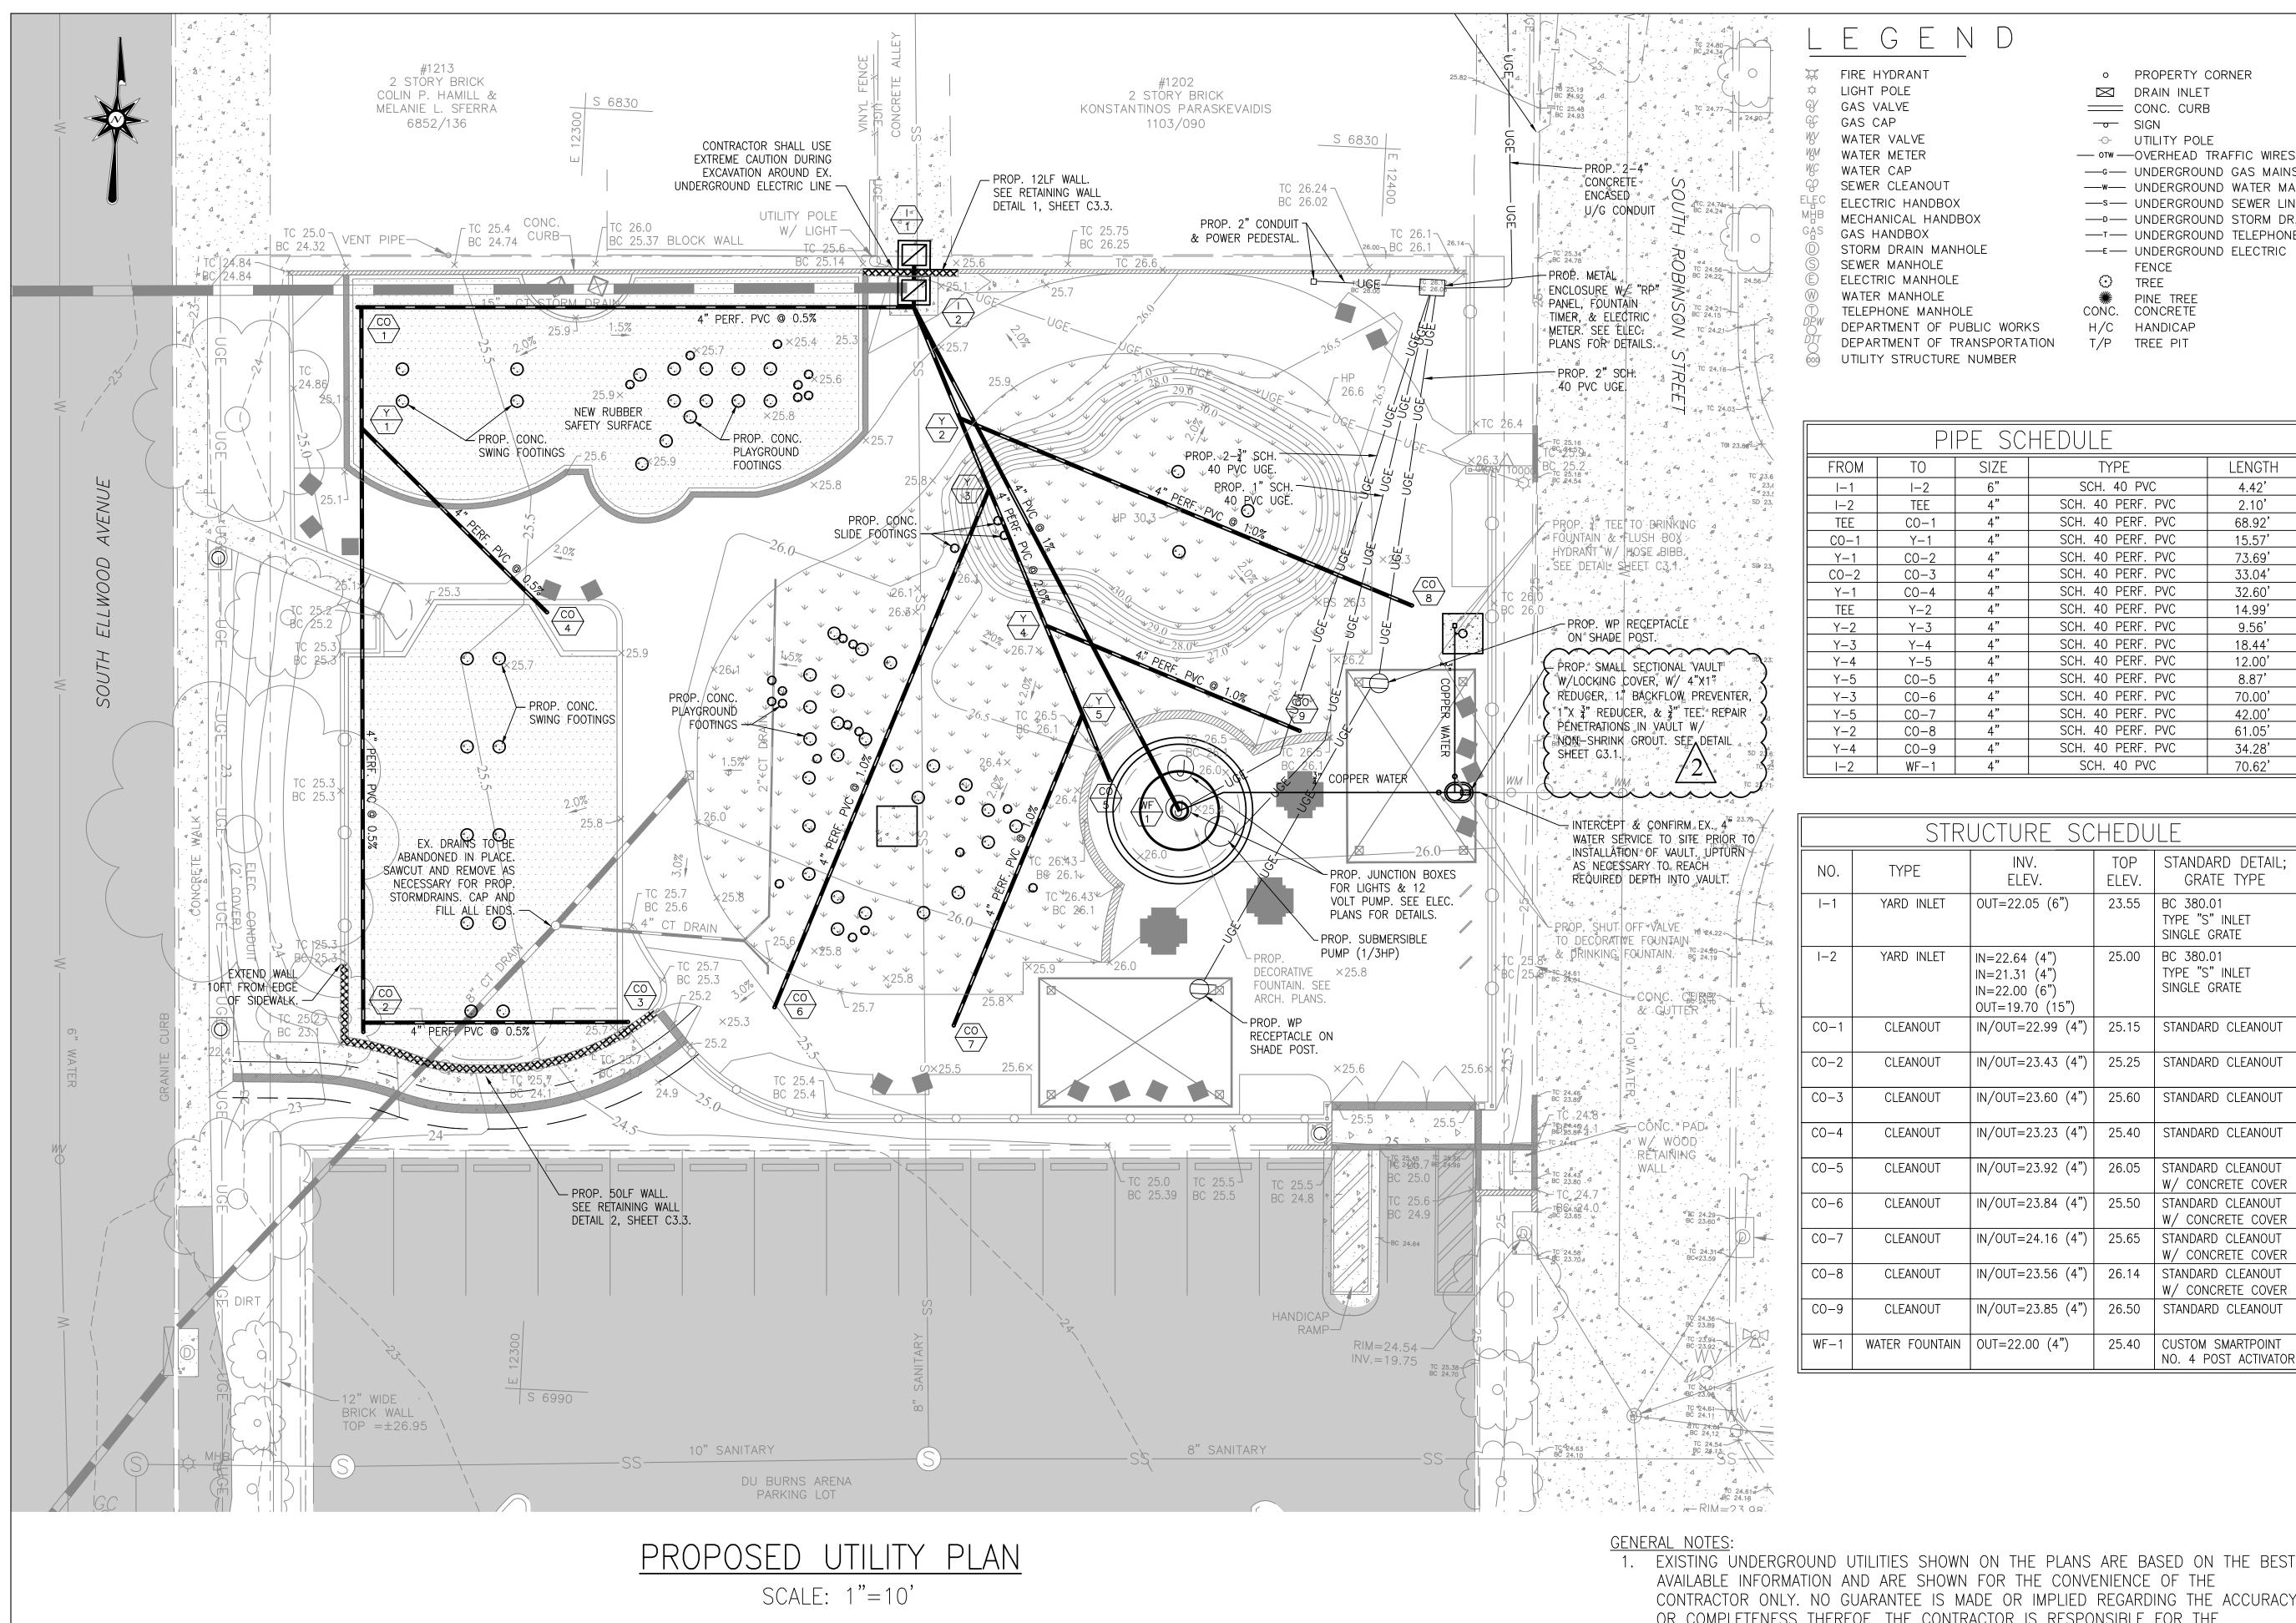

FIRE HYDRANT PROPERTY CORNER LIGHT POLE □ DRAIN INLET GAS VALVE === CONC. CURB GAS CAP → SIGN WATER VALVE -O- UTILITY POLE WATER METER --- OTW --- OVERHEAD TRAFFIC WIRES WATER CAP ——G—— UNDERGROUND GAS MAINS SEWER CLEANOUT ELECTRIC HANDBOX —s— UNDERGROUND SEWER LINES MECHANICAL HANDBOX — D— UNDERGROUND STORM DRAINS GAS HANDBOX —T— UNDERGROUND TELEPHONE STORM DRAIN MANHOLE —E— UNDERGROUND ELECTRIC SEWER MANHOLE FENCE ELECTRIC MANHOLE TREE

₩ PINE TREE

CONC. CONCRETE

H/C HANDICAP


T/P TREE PIT

| | PIPE SCHEDULE | | | | | |
|------|---------------|------|-------------------|--------|--|--|
| FROM | TO | SIZE | E TYPE LENGTH | | | |
| I-1 | I-2 | 6" | SCH. 40 PVC | 4.42' | | |
| I-2 | TEE | 4" | SCH. 40 PERF. PVC | 2.10' | | |
| TEE | CO-1 | 4" | SCH. 40 PERF. PVC | 68.92' | | |
| CO-1 | Y-1 | 4" | SCH. 40 PERF. PVC | 15.57 | | |
| Y-1 | CO-2 | 4" | SCH. 40 PERF. PVC | 73.69' | | |
| CO-2 | CO-3 | 4" | SCH. 40 PERF. PVC | 33.04' | | |
| Y-1 | CO-4 | 4" | SCH. 40 PERF. PVC | 32.60' | | |
| TEE | Y-2 | 4" | SCH. 40 PERF. PVC | 14.99' | | |
| Y-2 | Y-3 | 4" | SCH. 40 PERF. PVC | 9.56' | | |
| Y-3 | Y-4 | 4" | SCH. 40 PERF. PVC | 18.44' | | |
| Y-4 | Y-5 | 4" | SCH. 40 PERF. PVC | 12.00' | | |
| Y-5 | CO-5 | 4" | SCH. 40 PERF. PVC | 8.87' | | |
| Y-3 | CO-6 | 4" | SCH. 40 PERF. PVC | 70.00' | | |
| Y-5 | CO-7 | 4" | SCH. 40 PERF. PVC | 42.00' | | |
| Y-2 | CO-8 | 4" | SCH. 40 PERF. PVC | 61.05' | | |
| Y-4 | CO-9 | 4" | SCH. 40 PERF. PVC | 34.28' | | |
| I-2 | WF-1 | 4" | SCH. 40 PVC | 70.62' | | |

| | STRUCTURE SCHEDULE | | | | | | |
|------|--------------------|--|--------------|---|--|--|--|
| NO. | TYPE | INV. ELEV. | TOP ELEV. | STANDARD DETAIL; GRATE TYPE | | | |
| I—1 | YARD INLET | OUT=22.05 (6") | 23.55 | BC 380.01 TYPE "S" INLET SINGLE GRATE | | | |
| I-2 | YARD INLET | IN=22.64 (4") IN=21.31 (4") IN=22.00 (6") OUT=19.70 (15") | 25.00 | BC 380.01 TYPE "S" INLET SINGLE GRATE | | | |
| CO-1 | CLEANOUT | IN/OUT=22.99 (4") | 25.15 | STANDARD CLEANOUT | | | |
| CO-2 | CLEANOUT | IN/OUT=23.43 (4") | 25.25 | STANDARD CLEANOUT | | | |
| CO-3 | CLEANOUT | IN/OUT=23.60 (4") | 25.60 | STANDARD CLEANOUT | | | |
| CO-4 | CLEANOUT | IN/OUT=23.23 (4") | 25.40 | STANDARD CLEANOUT | | | |
| CO-5 | CLEANOUT | IN/OUT=23.92 (4") | 26.05 | STANDARD CLEANOUT W/ CONCRETE COVER | | | |
| CO-6 | CLEANOUT | IN/OUT=23.84 (4") | 25.50 | STANDARD CLEANOUT W/ CONCRETE COVER | | | |
| CO-7 | CLEANOUT | IN/OUT=24.16 (4") | 25.65 | STANDARD CLEANOUT W/ CONCRETE COVER | | | |
| CO-8 | CLEANOUT | IN/OUT=23.56 (4") | 26.14 | STANDARD CLEANOUT W/ CONCRETE COVER | | | |
| CO-9 | CLEANOUT | IN/OUT=23.85 (4") | 26.50 | STANDARD CLEANOUT | | | |
| WF-1 | WATER FOUNTAIN | OUT=22.00 (4") | 25.40 | CUSTOM SMARTPOINT NO. 4 POST ACTIVATO | | | |

KEYNOTES LISTED ON THIS SHEET ARE FOR CONVENIENCE ONLY. REFER TO SHEET CS.2 FOR COMPLETE LIST

KEY PLAN:

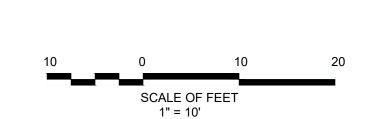



GWWO INC. 800 WYMAN PARK DRIVE, SUITE 300

(C) 2017 GWWO INC.

CERTIFY THAT THESE DOCUMENTS WERE PREPARED OR APPROVED BY ME, AND THAT I AM A DULY LICENSED ARCHITECT UNDER THE LAWS OF THE STATE OF A MARYLAND, LICENSE NUMBER 14446, EXPIRATION DATE 5/25/2021.

| No. | Date | Description |
|-----|----------|---------------|
| ^ | 10/06/20 | Addendum No.2 |

DYPSKI PARK RENOVATION

BALTIMORE CITY DEPT. OF RECREATION & PARKS: RP 178


Sheet


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|---------------|--------------------|-----|----------------|
| Scale | AS SHOWN | CMS | Checked |
| Date | 9/25/2020 | JAC | Approved |
| Drawing Title | | | Drawing Number |
| PROP | POSED UTILITY PLAN | | C1.1r |


AVAILABLE INFORMATION AND ARE SHOWN FOR THE CONVENIENCE OF THE CONTRACTOR ONLY. NO GUARANTEE IS MADE OR IMPLIED REGARDING THE ACCURACY OR COMPLETENESS THEREOF. THE CONTRACTOR IS RESPONSIBLE FOR THE VERIFICATION OF THE DEPTH, SIZE, MATERIAL, AND LOCATION OF ALL UNDERGROUND UTILITIES TO THEIR OWN SATISFACTION BEFORE BEGINNING ANY EXCAVATION OR UTILITY INSTALLATION. THE OWNER AND ENGINEER DISCLAIM ANY RESPONSIBILITY FOR THE ACCURACY OR COMPLETENESS OF SAID INFORMATION.


2. LIVE UNDERGROUND UTILITIES MAY EXIST WITHIN THE WORK AREA. CONTRACTOR SHALL USE EXTREME CAUTION AND SHALL COMPLY WITH APPLICABLE BALTIMORE CITY, LOCAL, STATE, AND FEDERAL REGULATIONS.


3. ALL WORK SHALL BE PERFORMED IN ACCORDANCE WITH, AND CONFORM TO THE CITY OF BALTIMORE DEPARTMENT OF PUBLIC WORKS SPECIFICATIONS FOR MATERIALS, HIGHWAYS, BRIDGES, UTILITIES AND INCIDENTAL STRUCTURES, 2006.

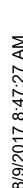


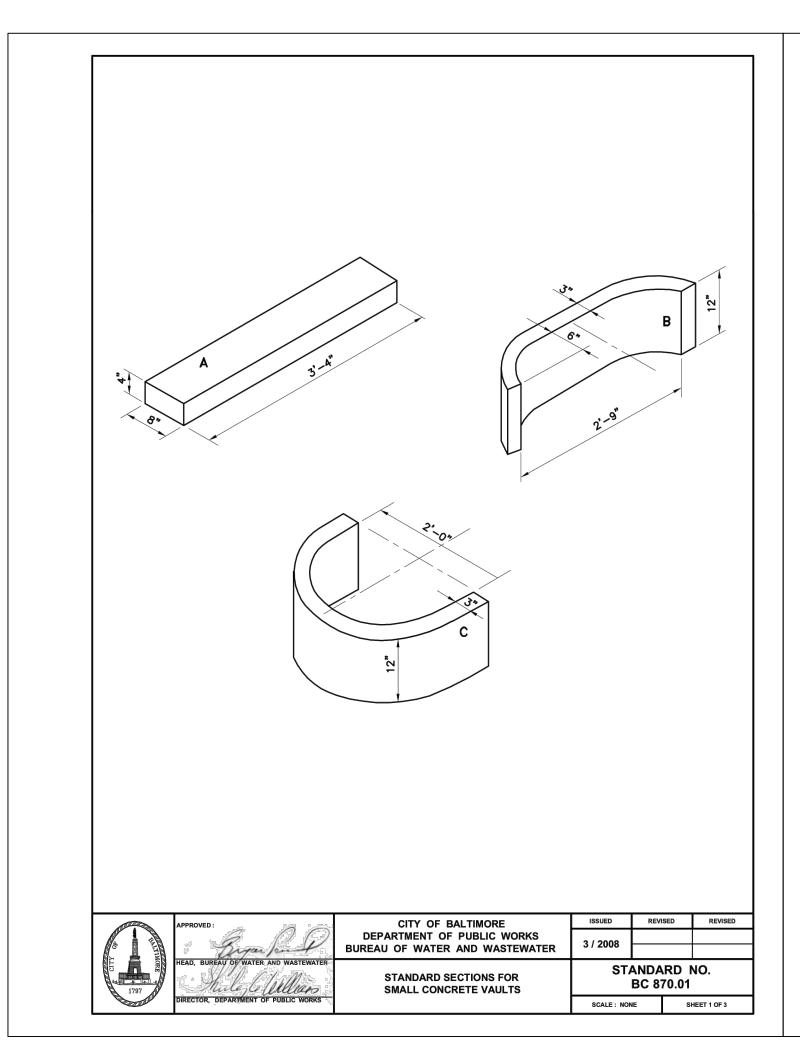

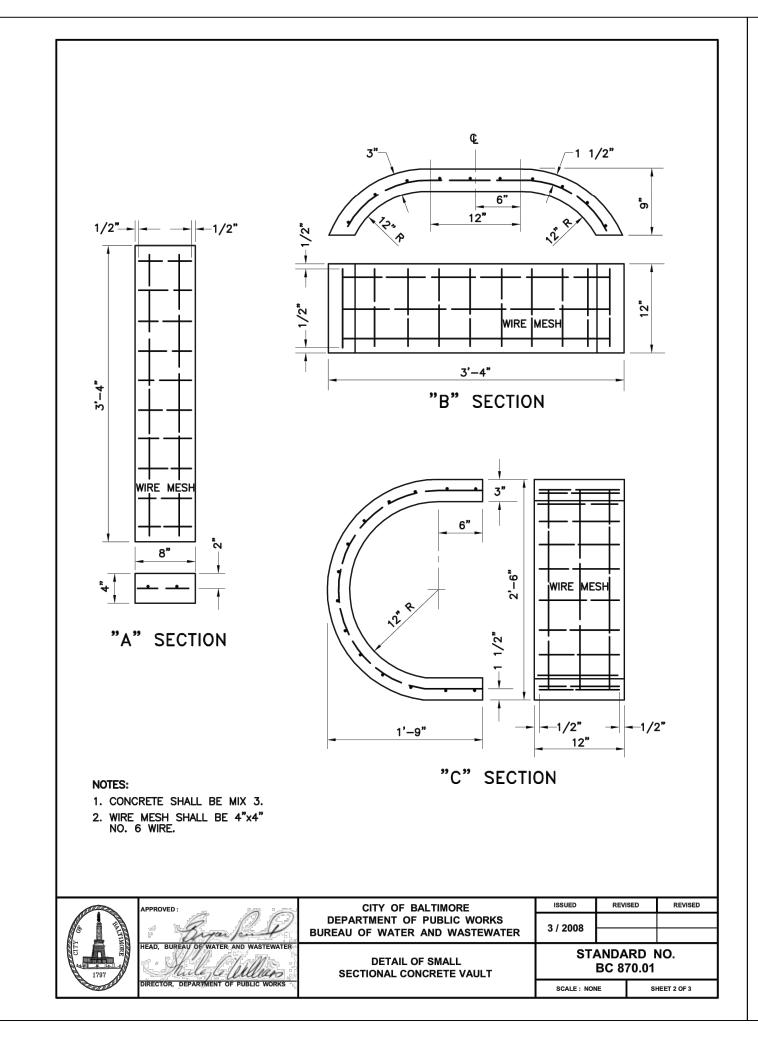


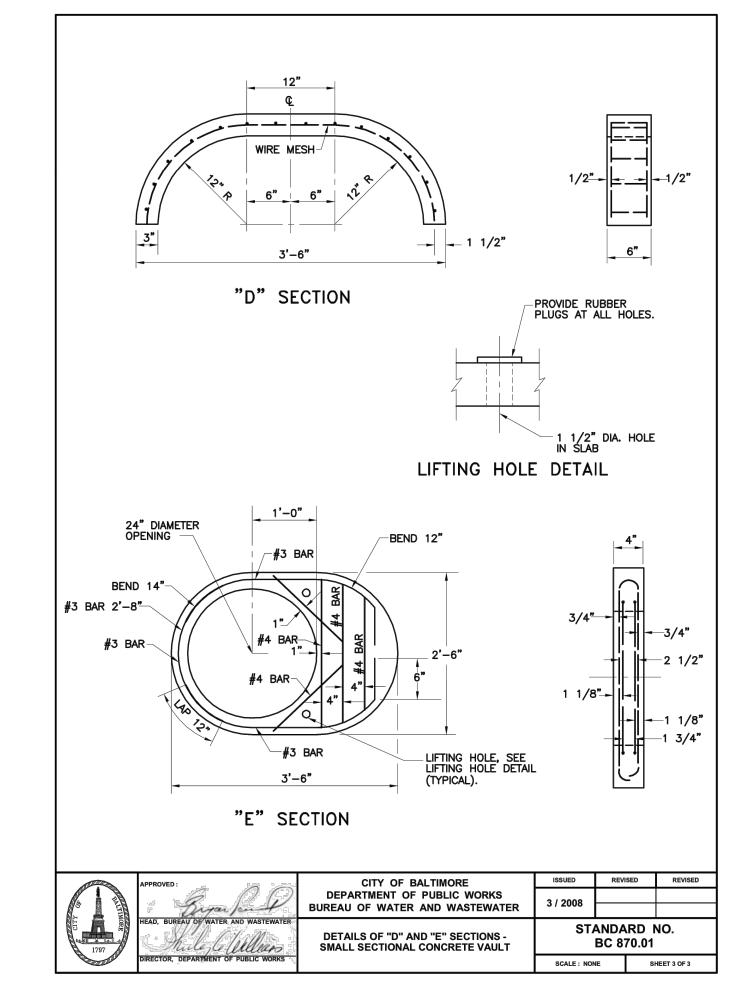

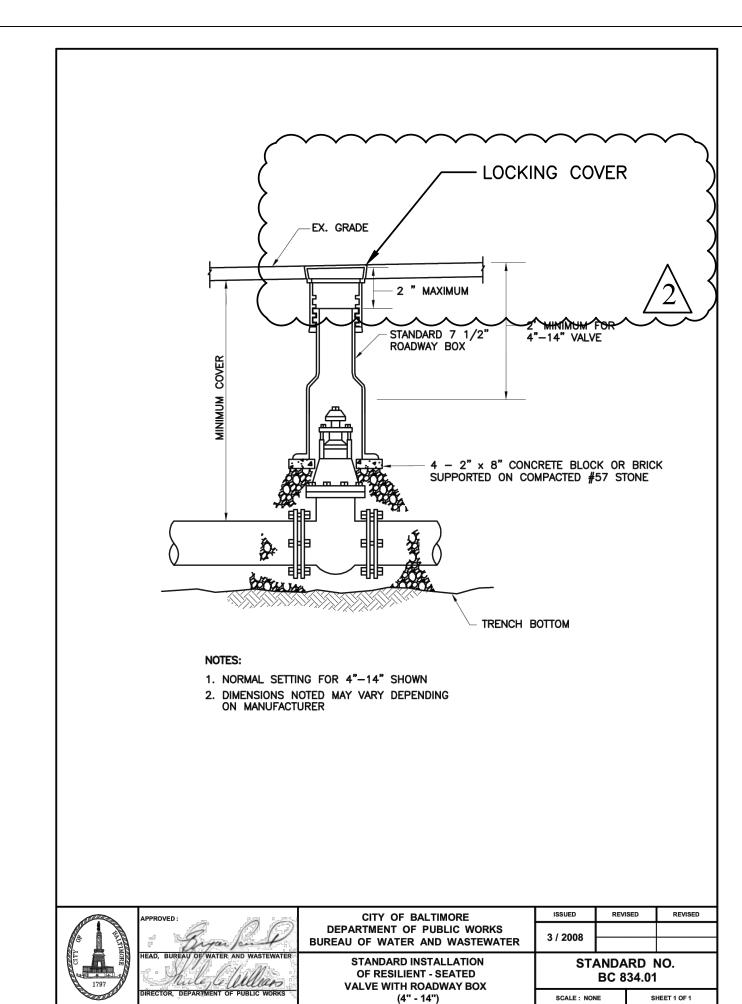


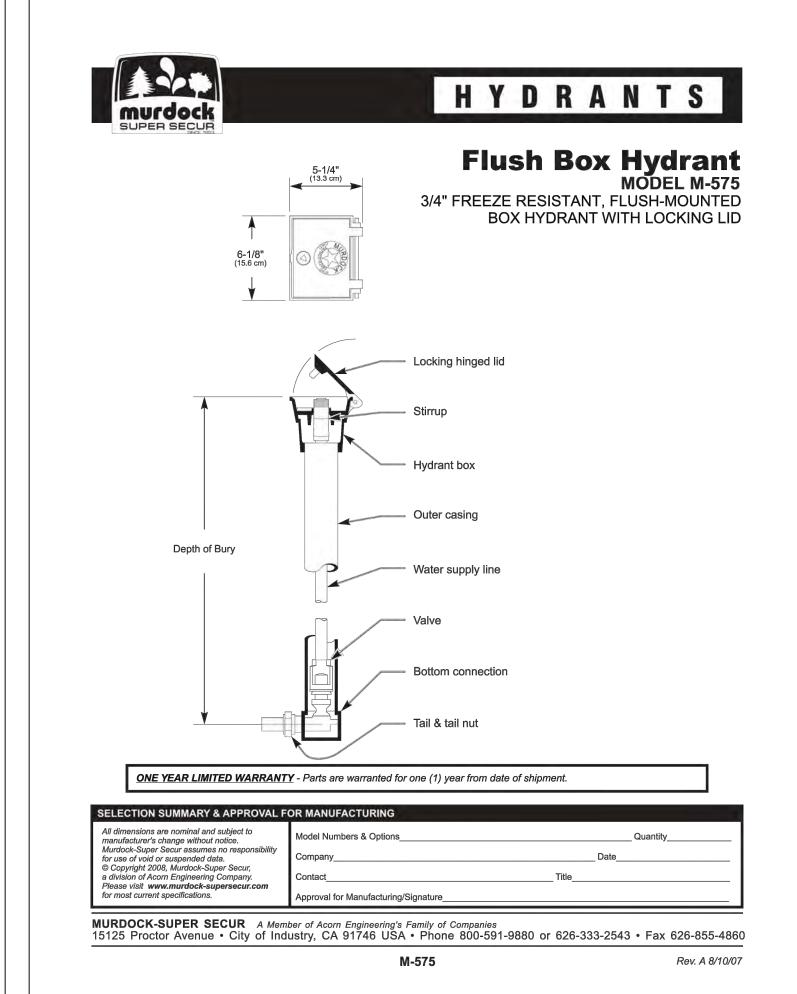





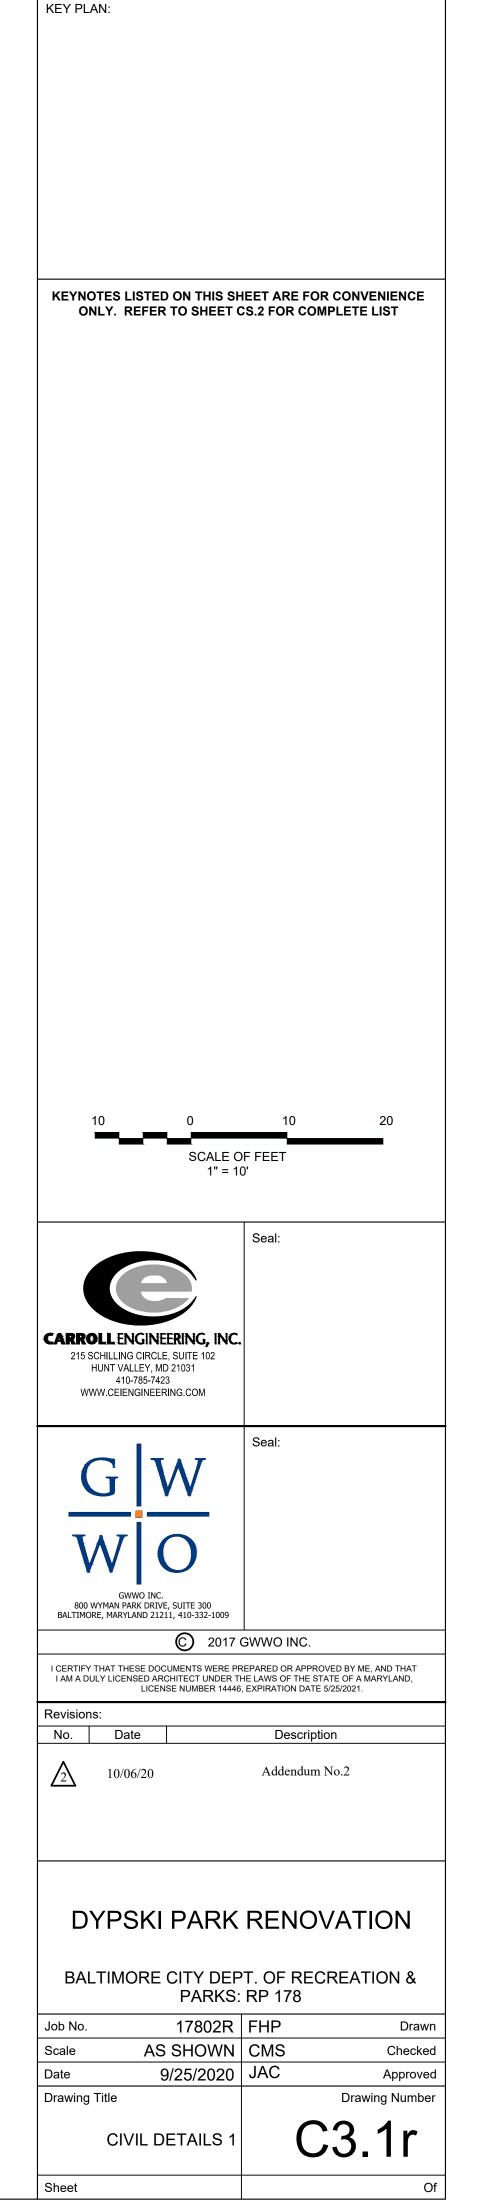



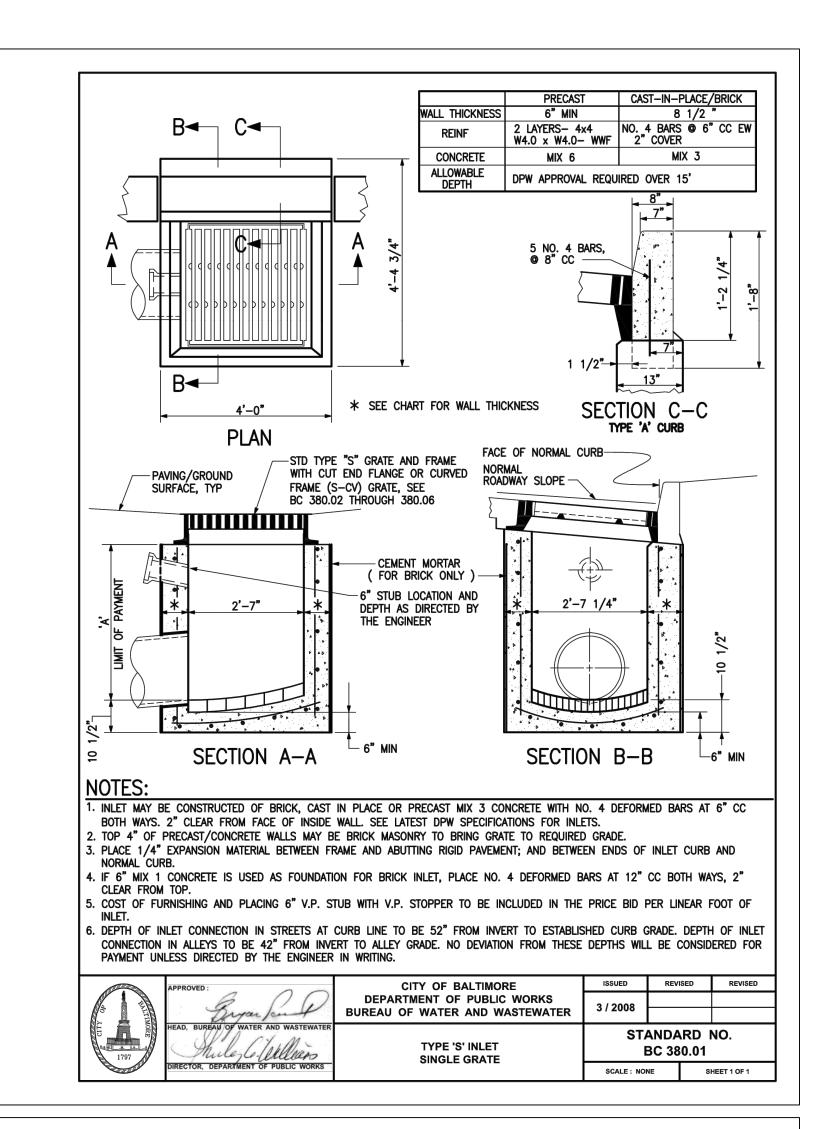


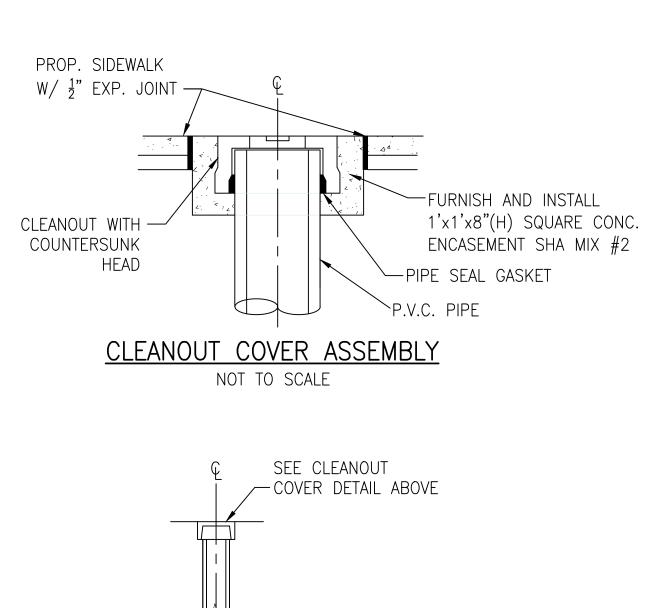


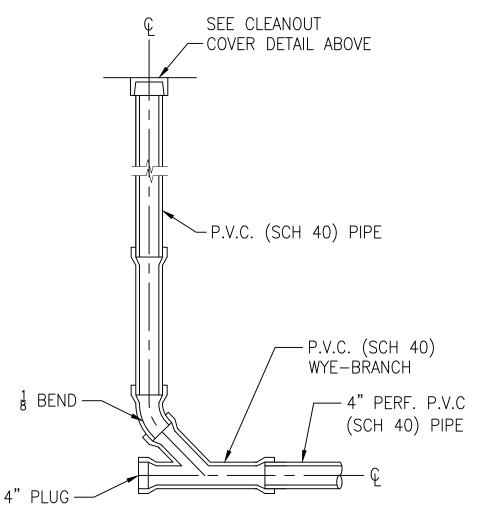



STANDARD CLEANOUT


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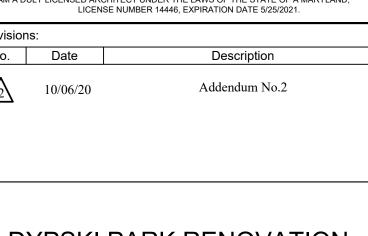


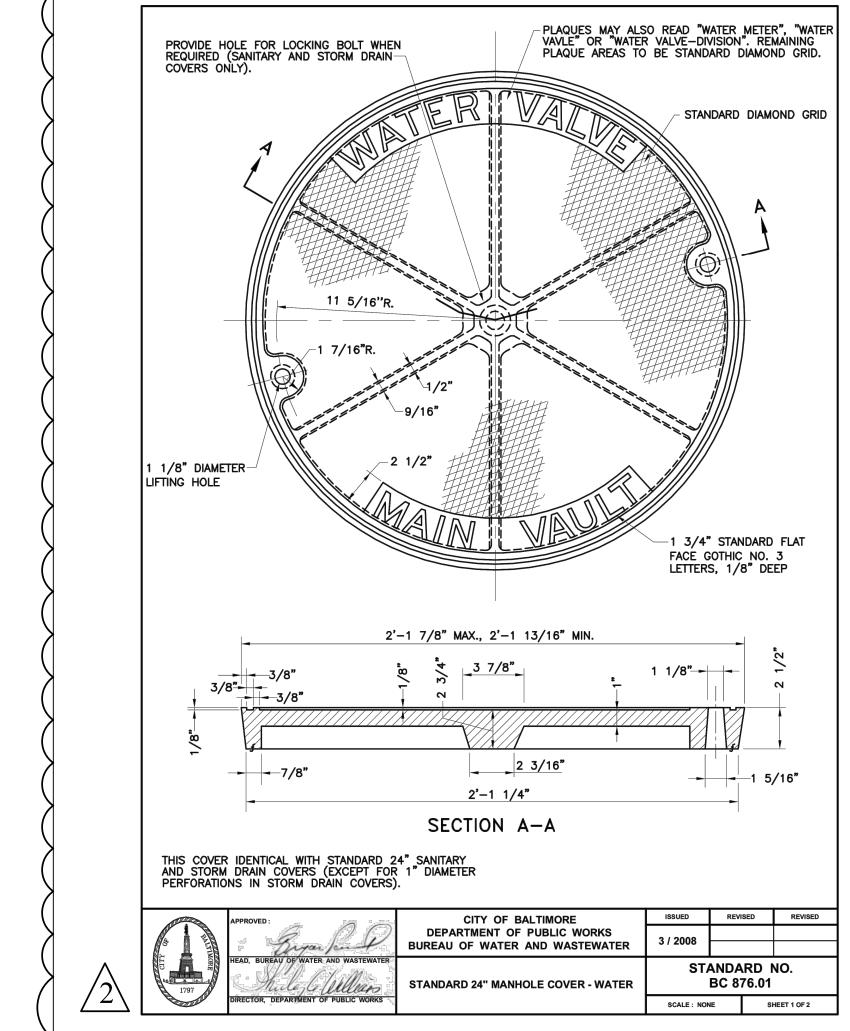

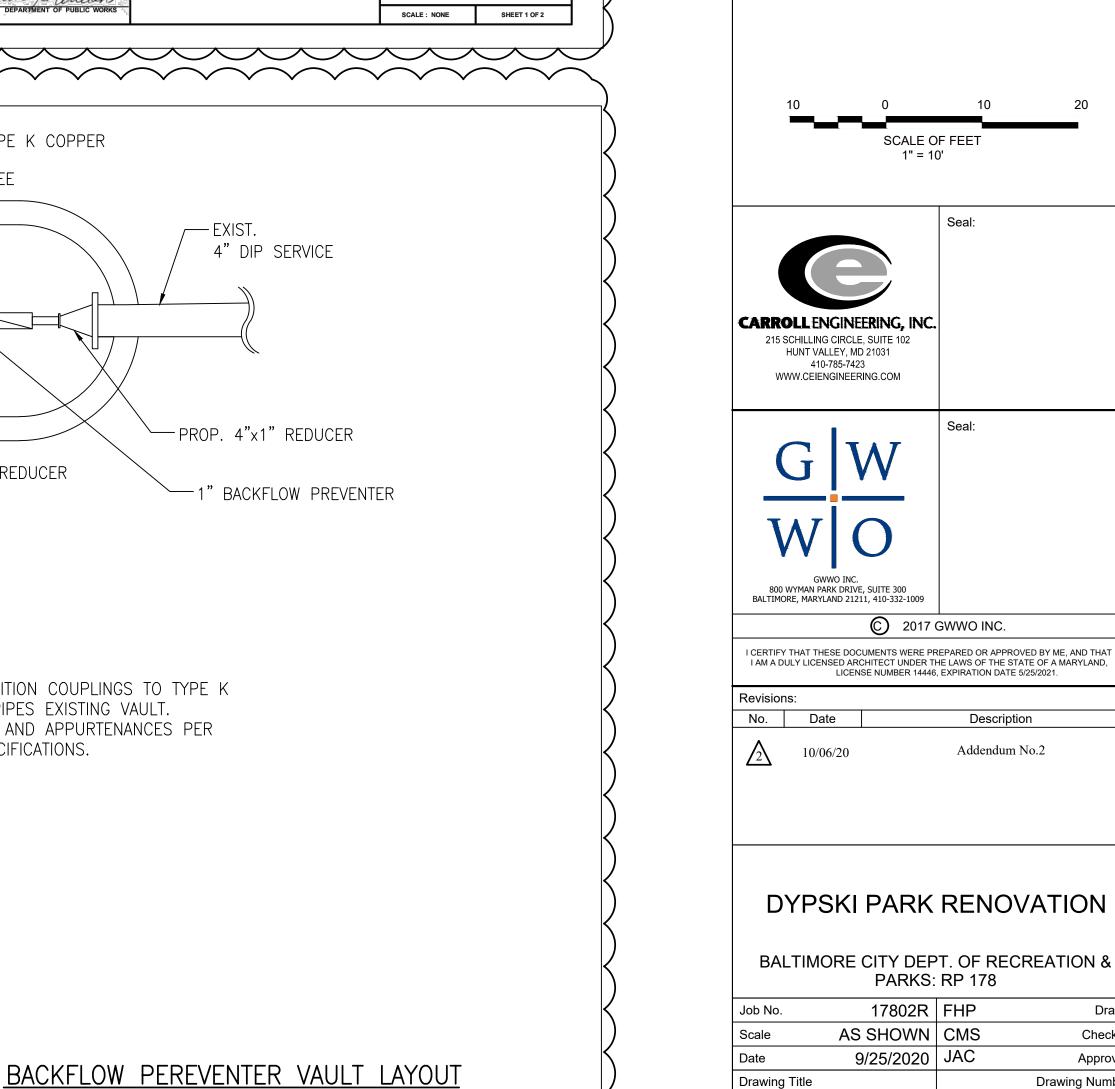

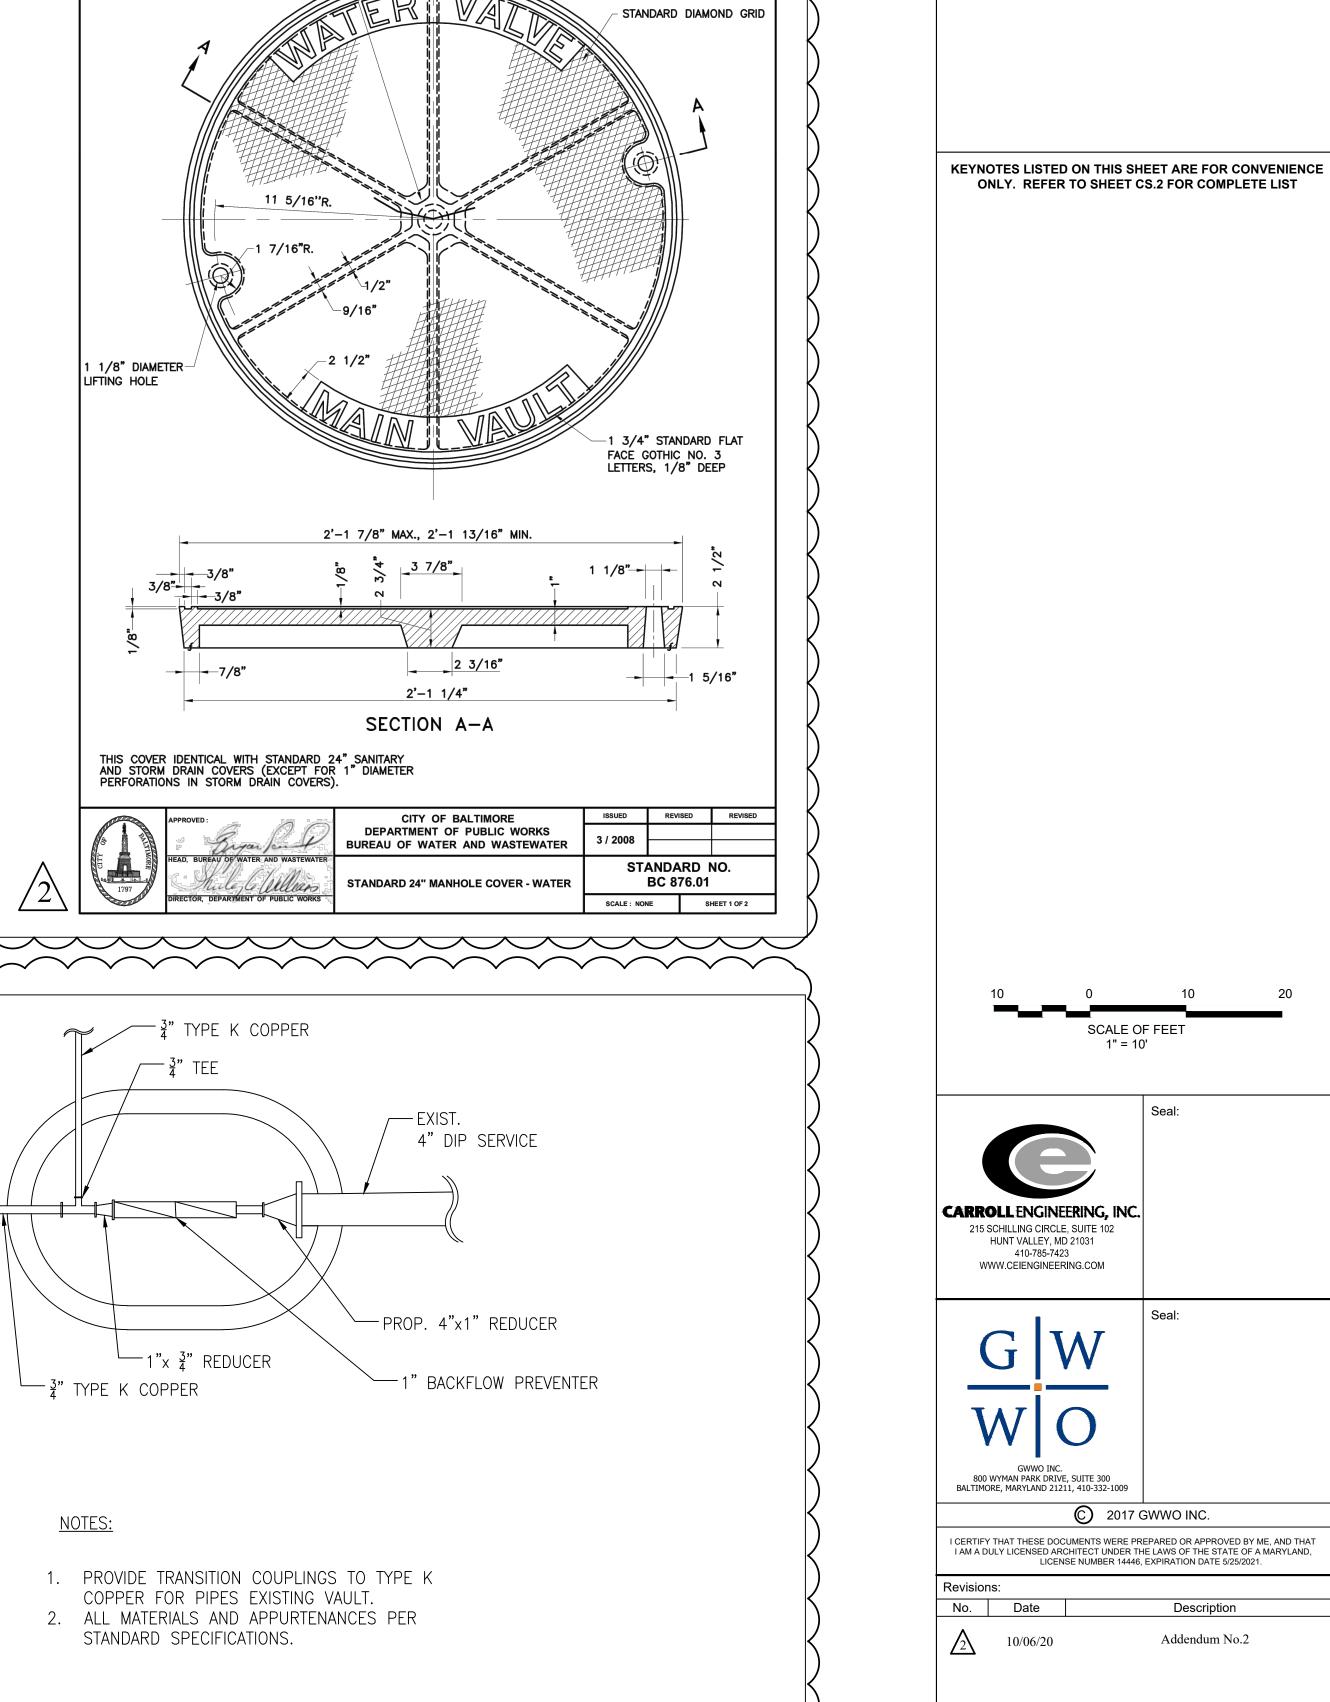

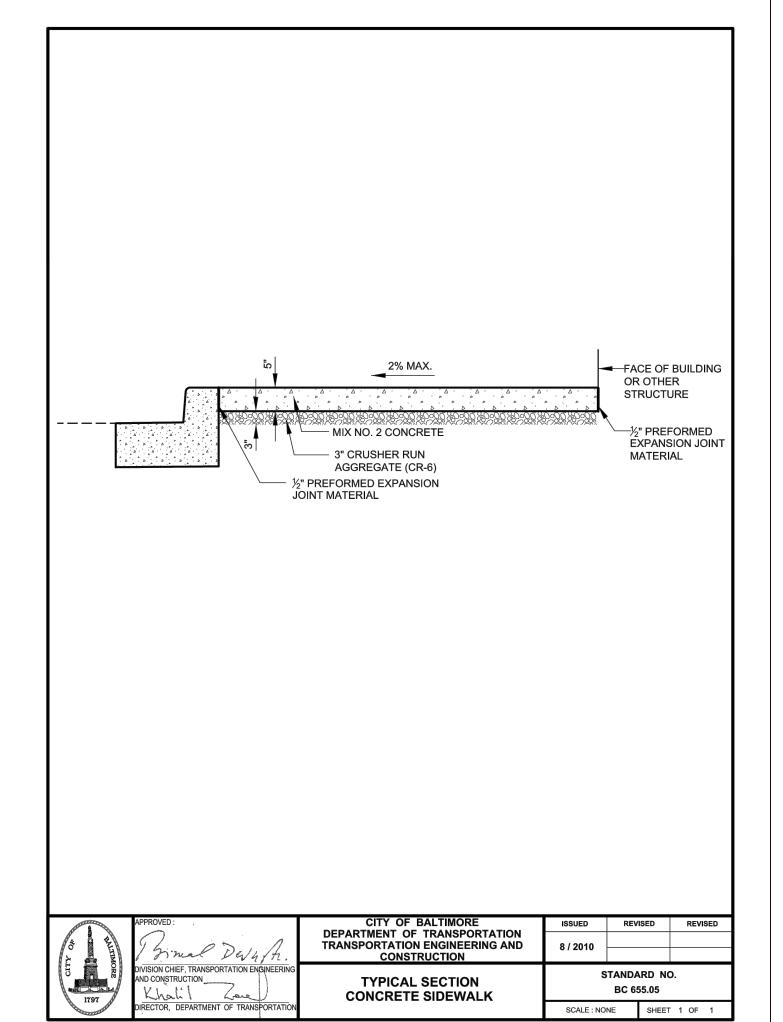

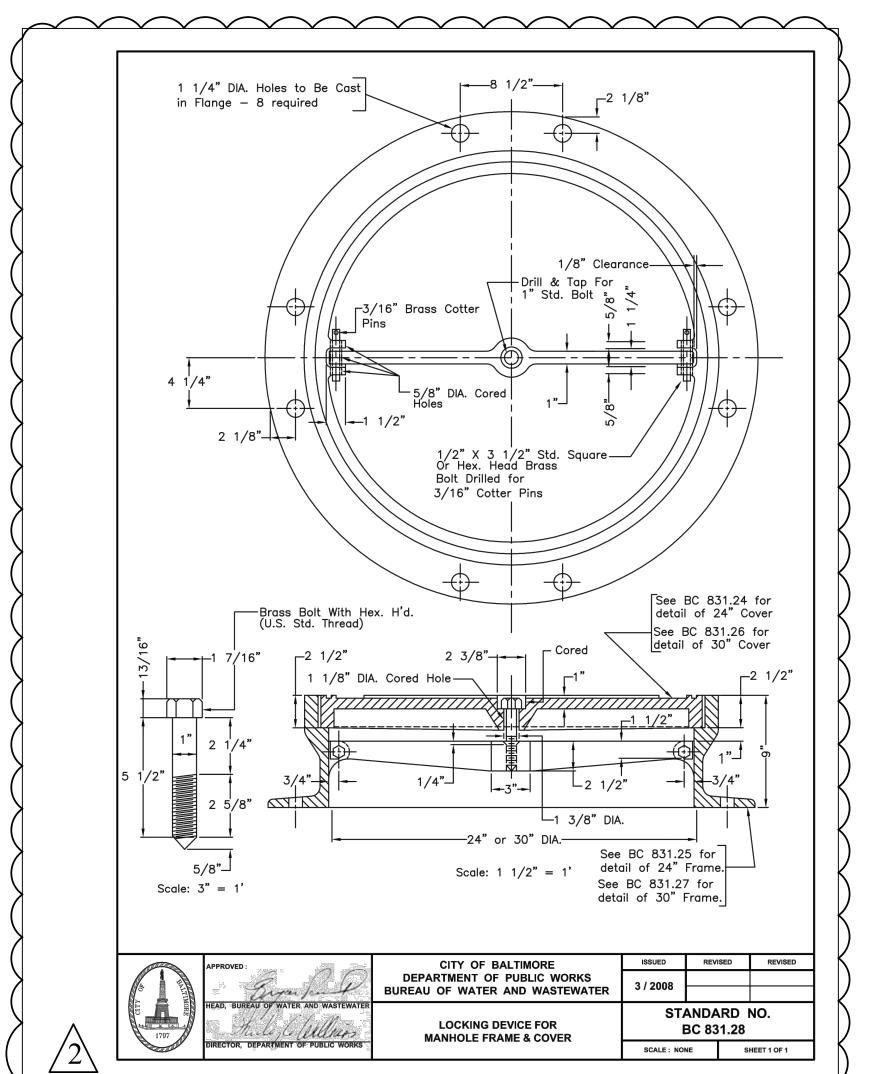


KEY PLAN:

BALTIMORE CITY DEPT. OF RECREATION &

| Job No. 17802R FHP Scale AS SHOWN CMS Date 9/25/2020 JAC Drawing Title Drawing Title | CIVIL DETAILS 2 | | | C3.2r |
|--|-----------------|-----------|-----|----------------|
| Scale AS SHOWN CMS | awing Title | | | Drawing Number |
| | te | 9/25/2020 | JAC | Approved |
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| 470000 5110 | b No. | 17802R | FHP | Drawn |

Sheet

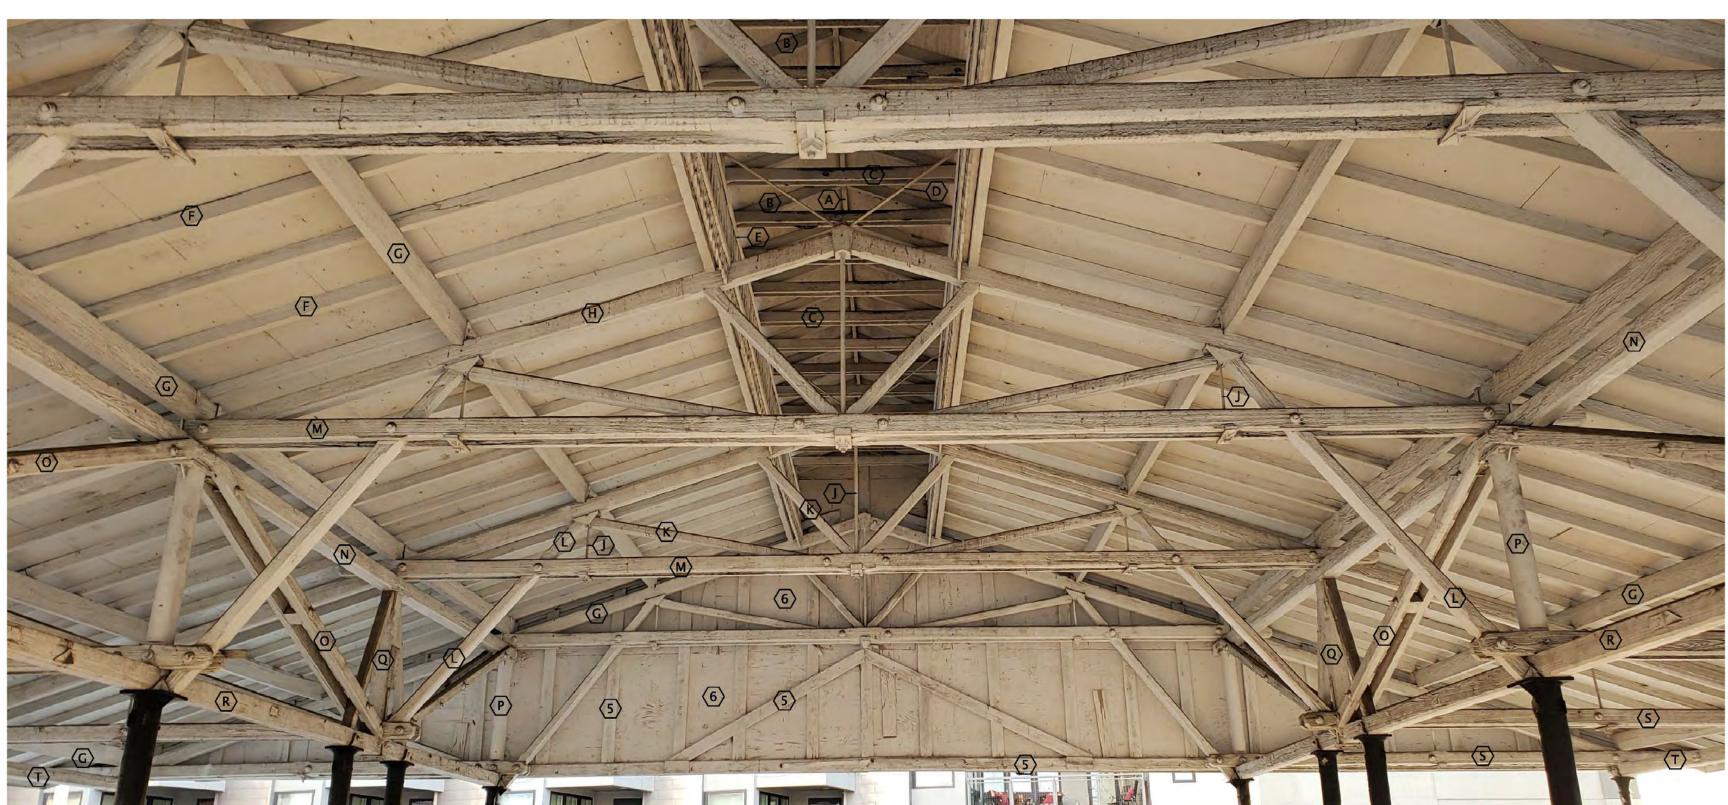

ITEMS TO SALVAGE FOR ERECTION ON NEW SITE INCLUDE **BUT ARE NOT LIMITED TO:**

- A. RIDGE RAFTER
- B. UPPER ROOF RAFTERS **UPPER ROOF CHORDS**
-). LOWER TRUSS-TO-CLERESTORY RODS
- CLERESTORY FRAMING SEE DETAIL PHOTO LOWER ROOF RAFTERS
- G. LOWER ROOF BEAMS
- H. TRANSVERSE TRUSSES (TT) TOP CHORDS
- NEW §" HAT CHANNELS (MAXIMUM SPAN 2'-0") AT MAXIMUM 42" O.C., MCELROY METAL MSG 1, 16 GA OR APPROVED EQUAL
- . TT TENSION RODS K. TT - WEB MEMBERS (VARIOUS)
- . TRANSVERSE-TRUSS-TO-LONGITUDINAL-TRUSS STRUTS
- M. TT UPPER BOTTOM CHORDS
- N. LONGITUDINAL TRUSSES (LT) TOP CHORDS
- O. LT WEB MEMBERS (VARIOUS) P. LT - COLUMN BEARING STRUTS (STEEL)
- Q. LT COLUMN BEARING STRUTS and WEBS (WOOD)
- R. LT BOTTOM CHORDS S. TT - LOWER BOTTOM CHORDS
- . LONGITUDINAL EDGE COLUMN BEARING BEAMS U. NEW 22 GA STEEL STANDING SEAM ROOF
- V. NEW RAKE TRIM TO MATCH NEW ROOF
- W. NEW REVERSE RAKE TRIM TO MATCH NEW ROOF X. NEW RIDGE COVER TO MATCH NEW ROOF
- . NEW COLUMN TYPE 1 "EDEN" (6") BY ARCHITECTURAL IRON COMPANY, OR APPROVED EQUAL. Z. NEW COLUMN TYPE 2 - "EXETER" (4") BY ARCHITECTURAL IRON COMPANY, OR APPROVED EQUAL.

THE LIST ABOVE IS NOT A COMPREHENSIVE LIST OF EVERY PIECE OF THE STRUCTURO-SKELETAL SYSTEM TO BE ERECTED. IT IS THE BIDDING CONTRACTORS RESPONSIBILITY TO SALVAGE ALL PARTS AS NECESSARY TO ERECT THE PAVILION ON THE NEW SITE. ANY COMPONENTS NOT SALVAGED, DAMAGED, LOST, ETC. ARE THE CONTRACTOR'S RESPONSIBILITY TO ACCOUNT FOR. ANY NEW REPLACEMENTS PARTS MUST BE APPROVED BY THE ENGINEER.





ITEMS NOT INTENDED FOR RE-USE ON NEW SITE INCLUDE BUT ARE NOT LIMITED TO:

- 1. UPPER ROOF, INCLUDING RIDGE COVER, SHEATHING, AND DRIP-EDGES
- 2. CLERESTORY COVER/SIDING 3. LOWER ROOF, INCLUDING SHEATHING, AND DRIP-EDGES
- 4. MAIN FASCIA COVER/SIDING INCLUDING: FRAMING and
- SHEATHING
- MAJOR/CENTRAL CAST-IRON COLUMNS

Block 1898

Lot

8. MINOR/LONGITUDINAL EDGE CAST-IRON COLUMNS

THE LIST ABOVE IS NOT A COMPREHENSIVE LIST OF EVERY ELEMENT TO BE

CITY OF BALTIMORE DEPARTMENT OF RECREATION AND PARKS **DEMOLITION PLAN AND**


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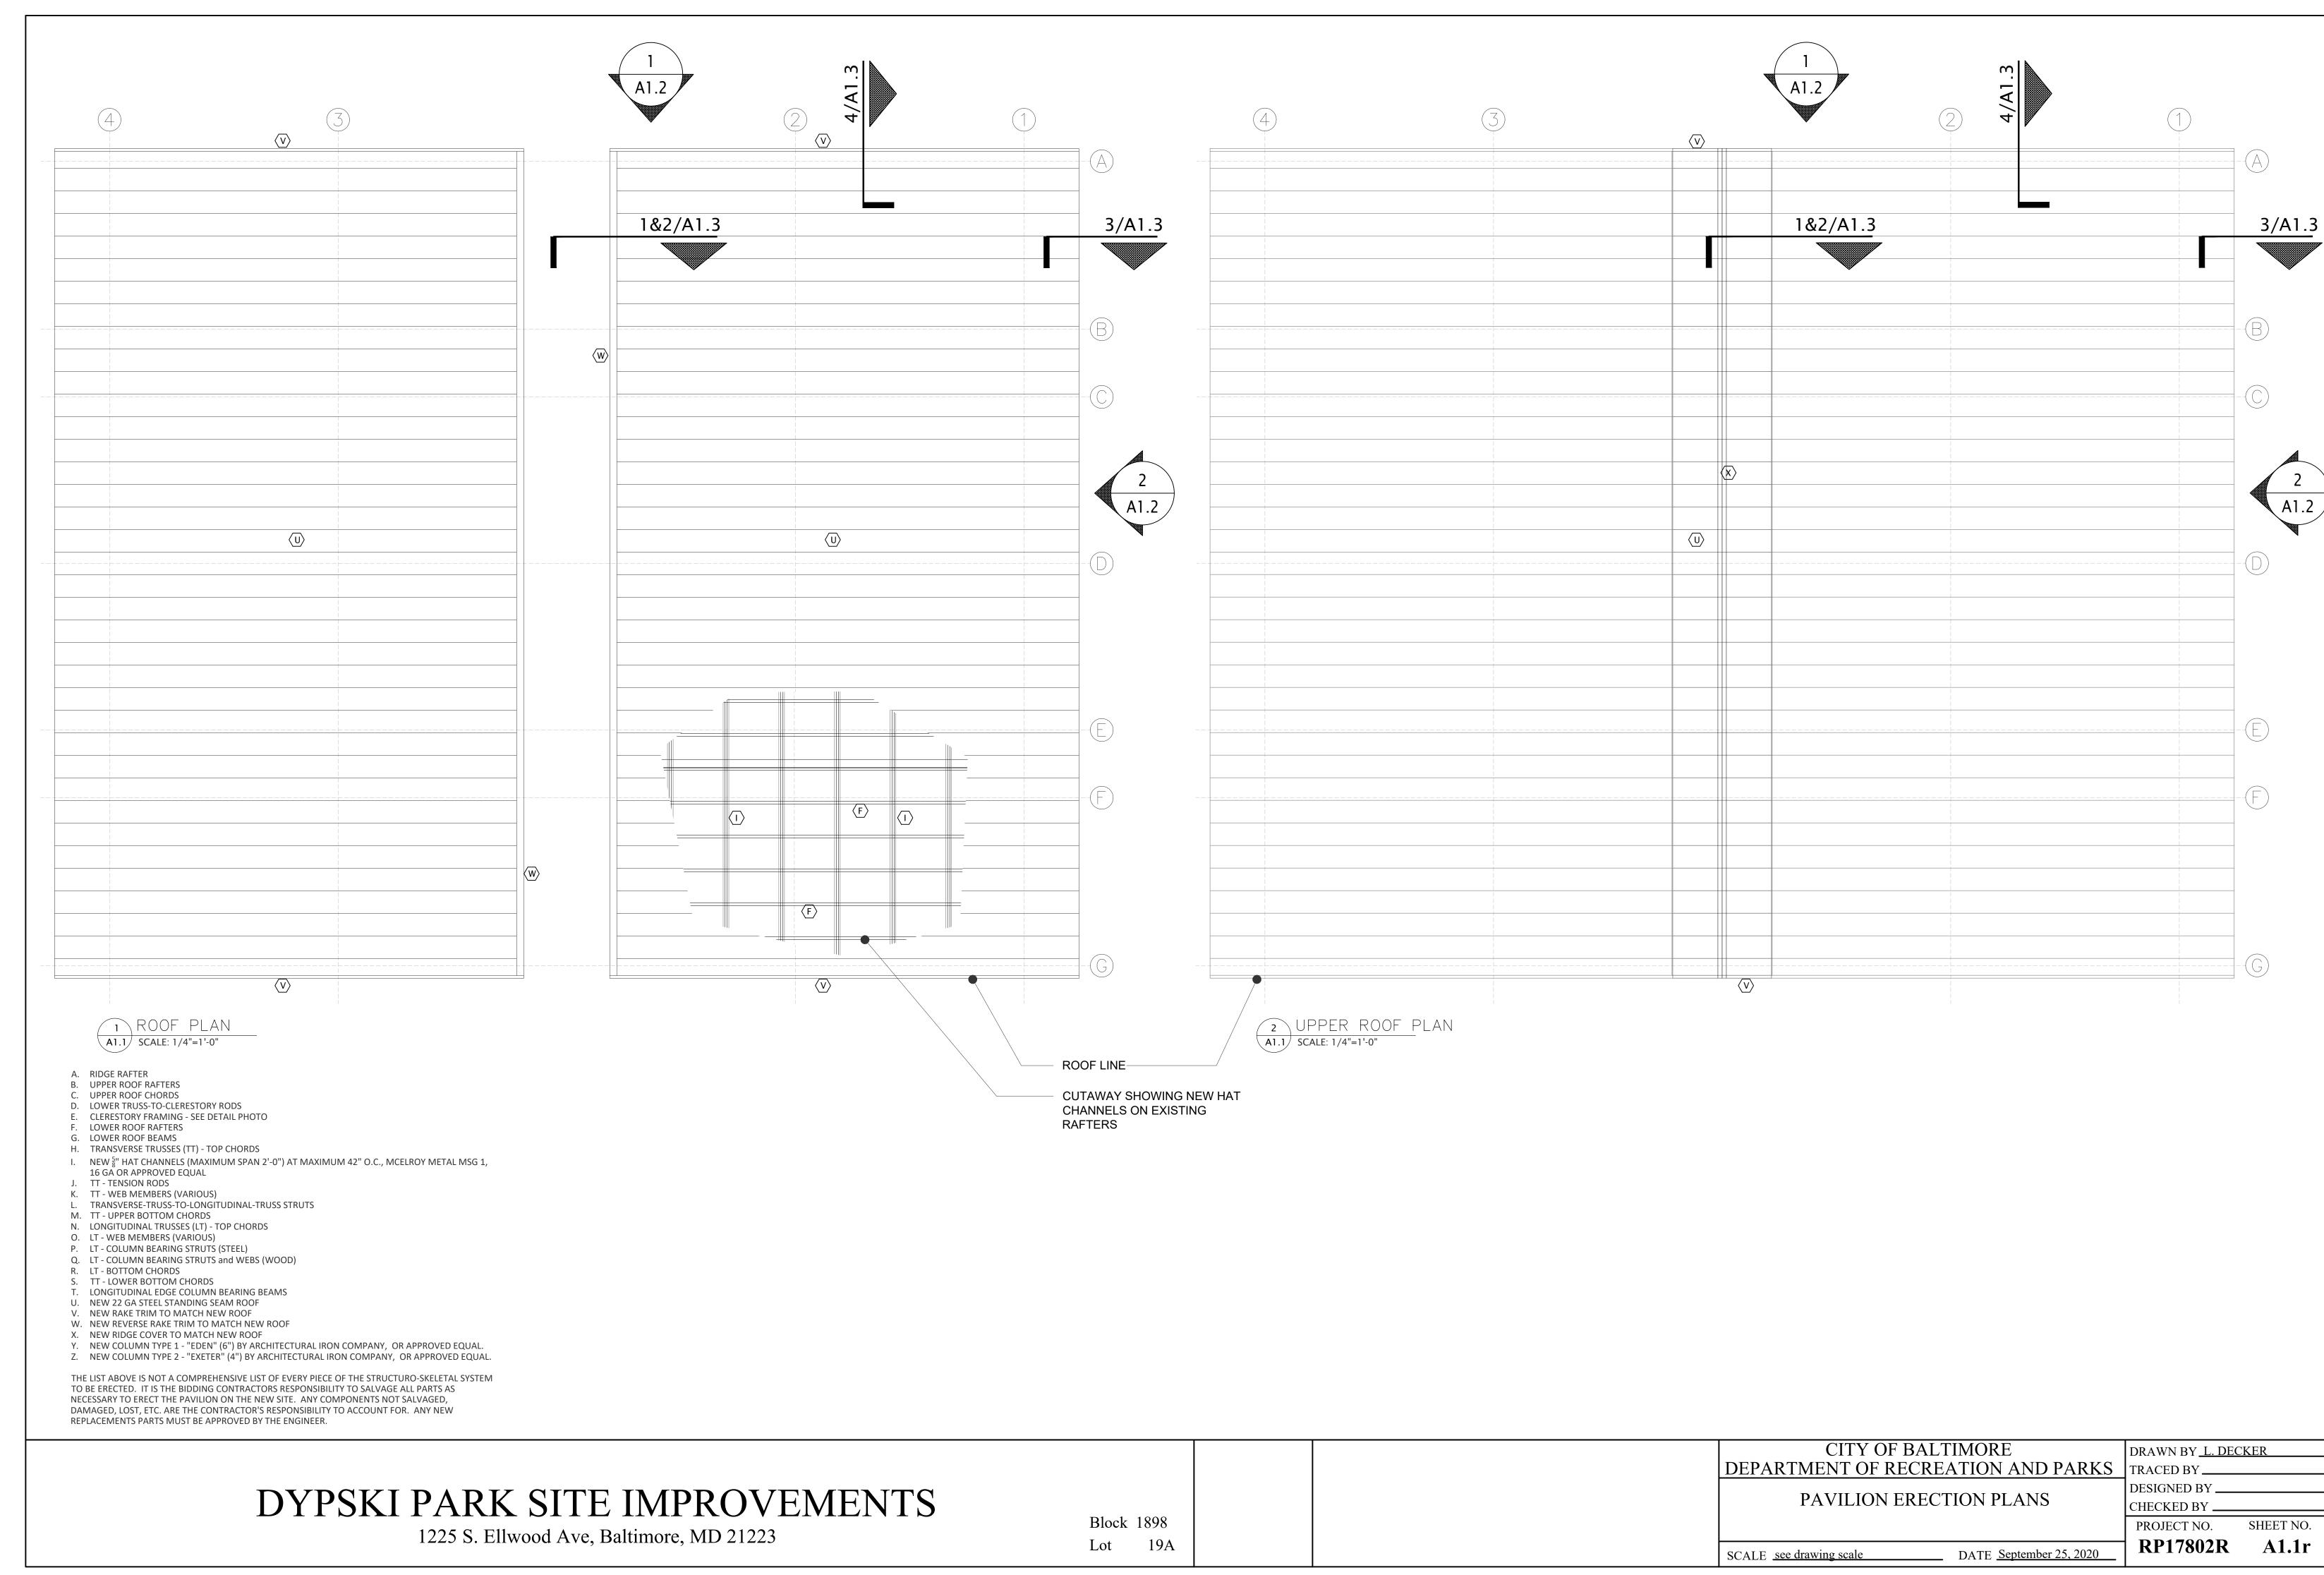
DRAWN BY <u>L. DECKER</u> TRACED BY_ DESIGNED BY _ CHECKED BY SHEET NO. PROJECT NO.


DATE September 25, 2020 SCALE NTS

L1.1r

RP17802R



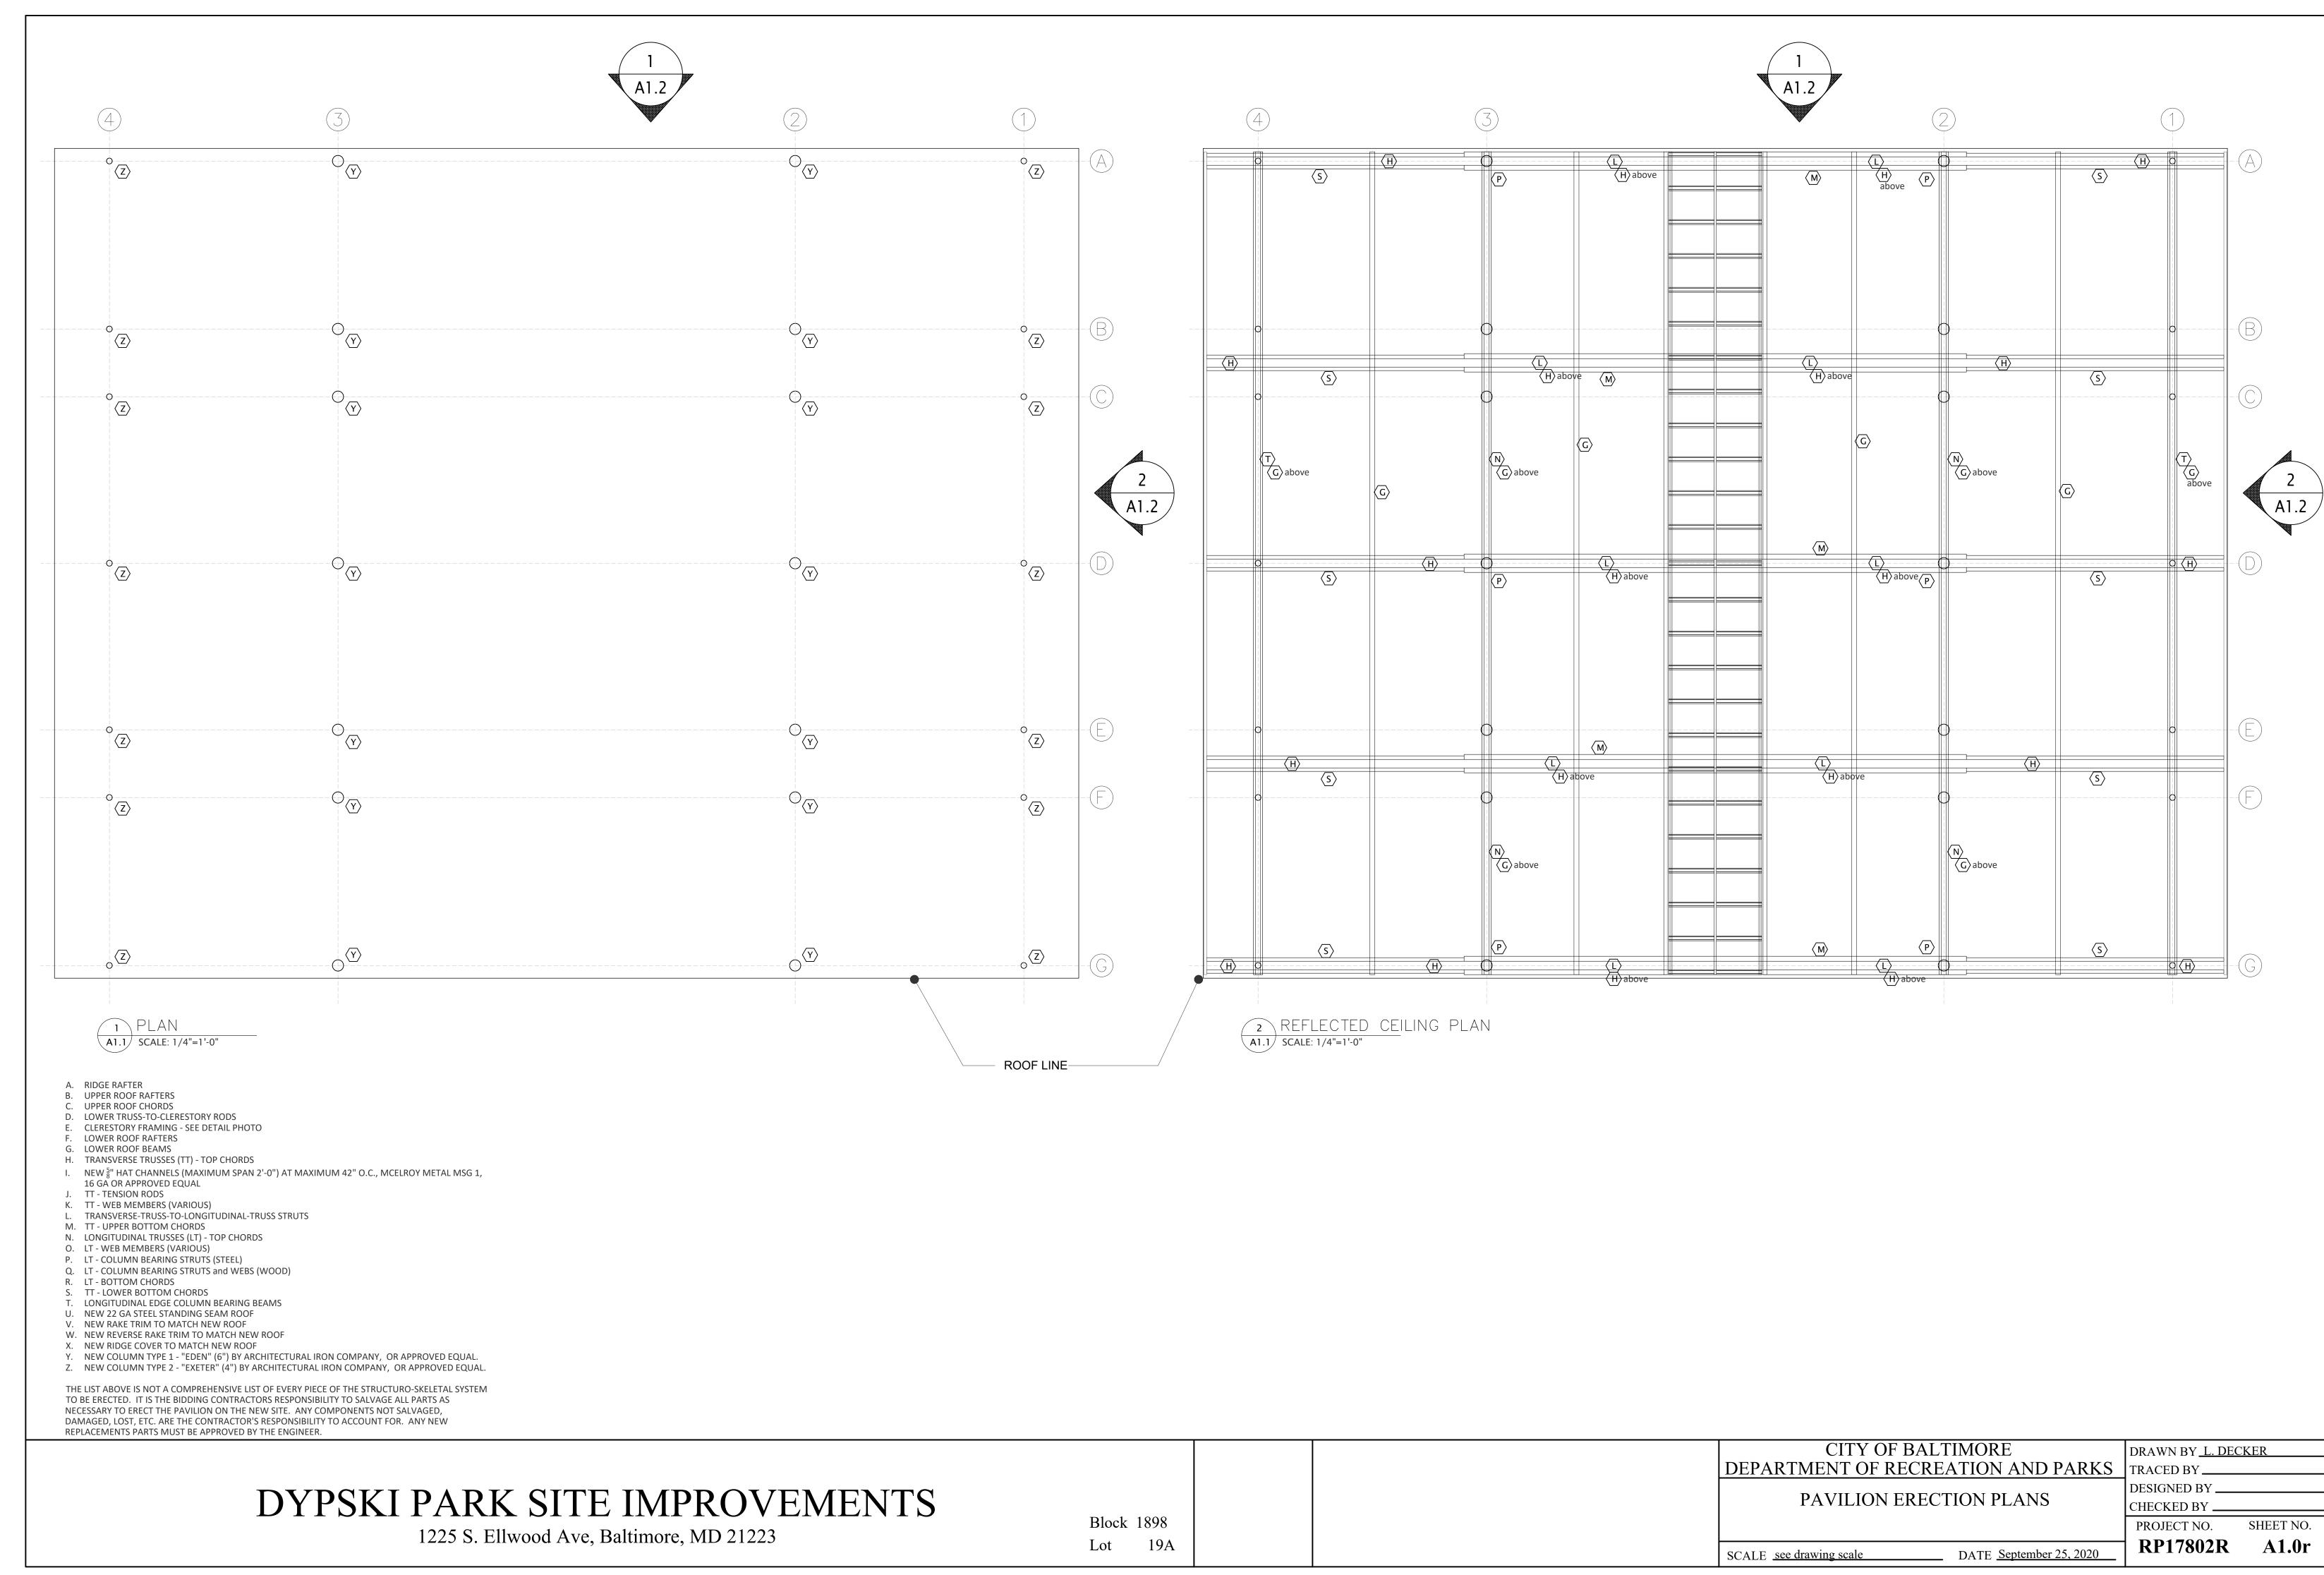

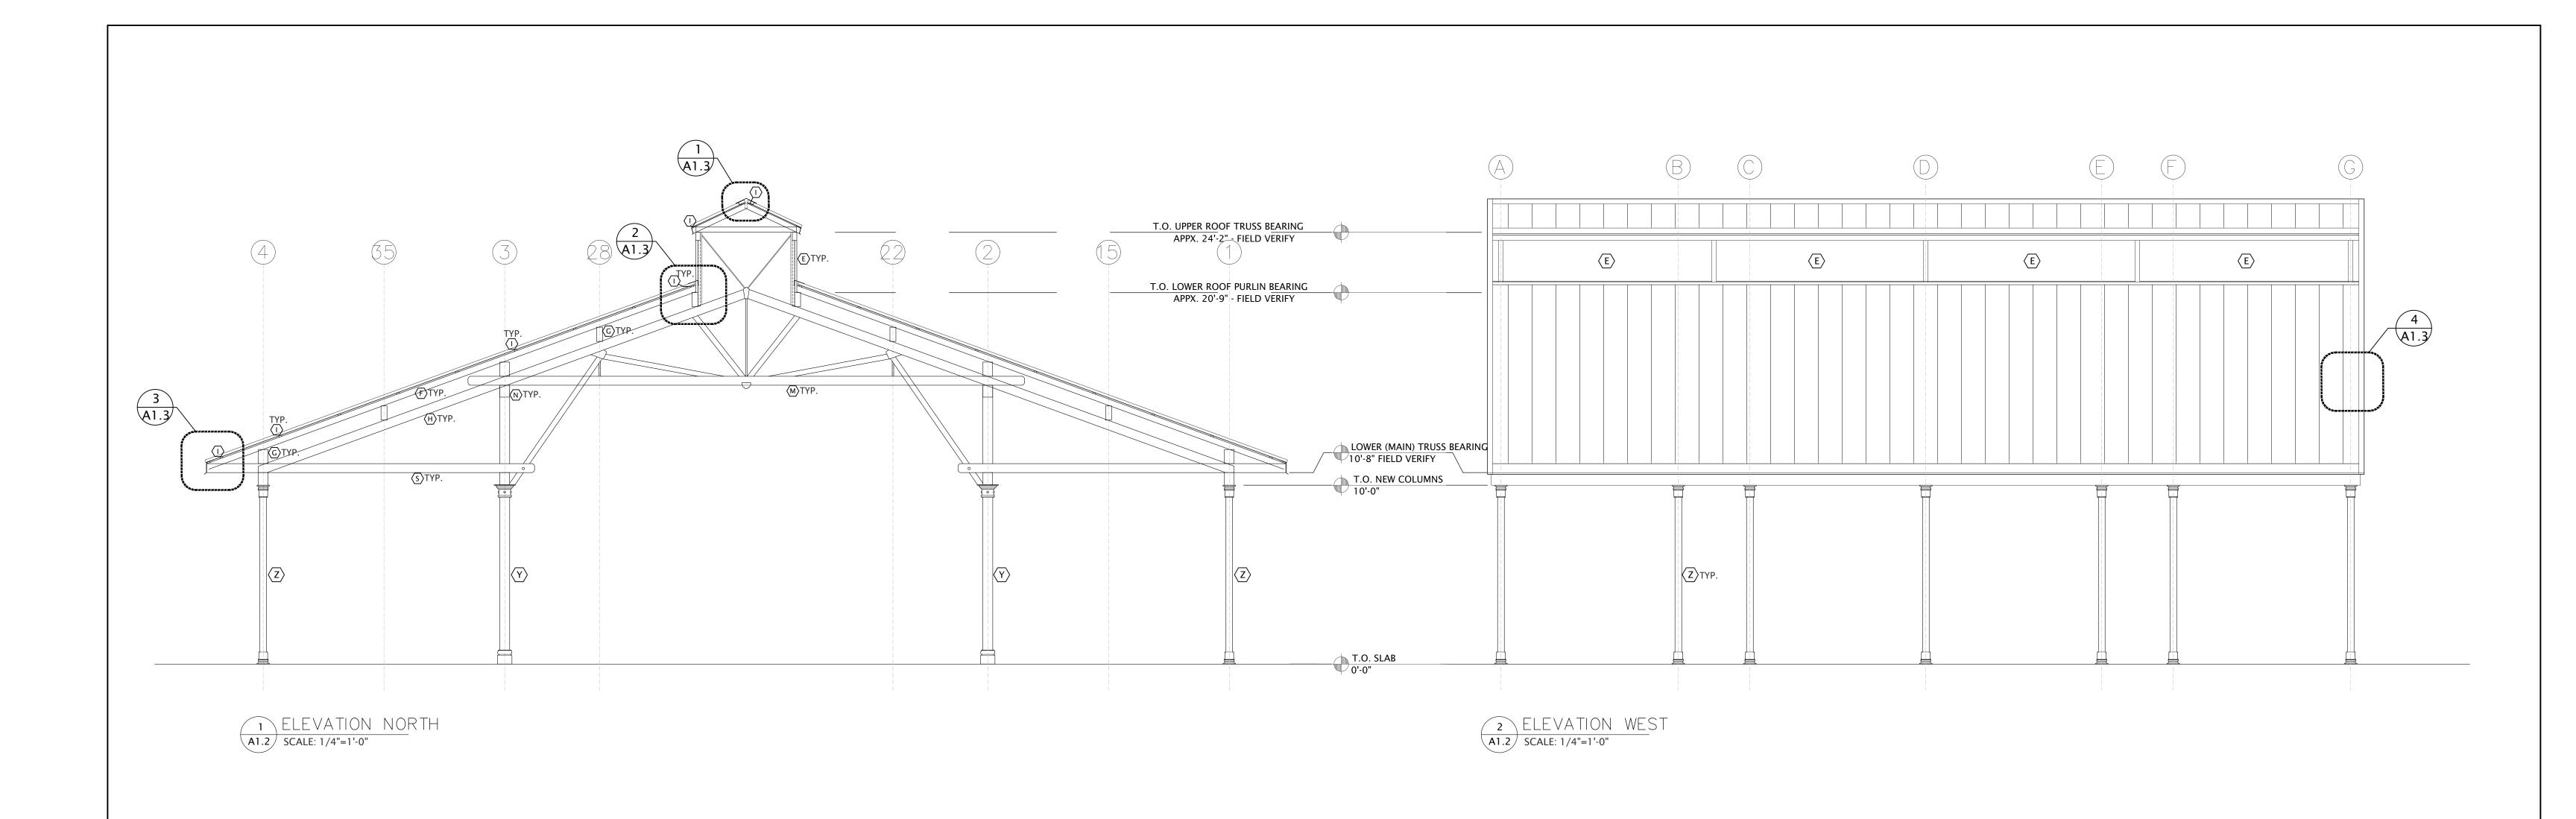

- A. RIDGE RAFTER
- B. UPPER ROOF RAFTERS
- . UPPER ROOF CHORDS
- D. LOWER TRUSS-TO-CLERESTORY RODSE. CLERESTORY FRAMING SEE DETAIL PHOTO
- F. LOWER ROOF RAFTERSG. LOWER ROOF BEAMS
- H. TRANSVERSE TRUSSES (TT) TOP CHORDS
- J. TT TENSION RODS
 K. TT WEB MEMBERS (VARIOUS)
- L. TRANSVERSE-TRUSS-TO-LONGITUDINAL-TRUSS STRUTS
 M. TT UPPER BOTTOM CHORDS
- N. LONGITUDINAL TRUSSES (LT) TOP CHORDS
- O. LT WEB MEMBERS (VARIOUS)
 P. LT COLLIMN BEARING STRUTS (STE
- P. LT COLUMN BEARING STRUTS (STEEL)Q. LT COLUMN BEARING STRUTS and WEBS (WOOD)
- R. LT BOTTOM CHORDSS. TT LOWER BOTTOM CHORDS
- T. LONGITUDINAL EDGE COLUMN BEARING BEAMSU. NEW 22 GA STEEL STANDING SEAM ROOF
- V. NEW RAKE TRIM TO MATCH NEW ROOF
 W. NEW REVERSE RAKE TRIM TO MATCH NEW ROOF
- X. NEW RIDGE COVER TO MATCH NEW ROOF
- Y. NEW COLUMN TYPE 1 "EDEN" (6") BY ARCHITECTURAL IRON COMPANY, OR APPROVED EQUAL.

 Z. NEW COLUMN TYPE 2 "EXETER" (4") BY ARCHITECTURAL IRON COMPANY, OR APPROVED EQUAL.

I. NEW $\frac{5}{8}$ " HAT CHANNELS (MAXIMUM SPAN 2'-0") AT MAXIMUM 42" O.C., MCELROY METAL MSG 1,

THE LIST ABOVE IS NOT A COMPREHENSIVE LIST OF EVERY PIECE OF THE STRUCTURO-SKELETAL SYSTEM TO BE ERECTED. IT IS THE BIDDING CONTRACTORS RESPONSIBILITY TO SALVAGE ALL PARTS AS NECESSARY TO ERECT THE PAVILION ON THE NEW SITE. ANY COMPONENTS NOT SALVAGED, DAMAGED, LOST, ETC. ARE THE CONTRACTOR'S RESPONSIBILITY TO ACCOUNT FOR. ANY NEW REPLACEMENTS PARTS MUST BE APPROVED BY THE ENGINEER.

DYPSKI PARK SITE IMPROVEMENTS

1225 S. Ellwood Ave, Baltimore, MD 21223

Block 1898 Lot 19A CITY OF BALTIMORE
DEPARTMENT OF RECREATION AND PARKS
PAVILION ERECTION ELEVATIONS

DATE September 25, 2020

DRAWN BY L. DECKER

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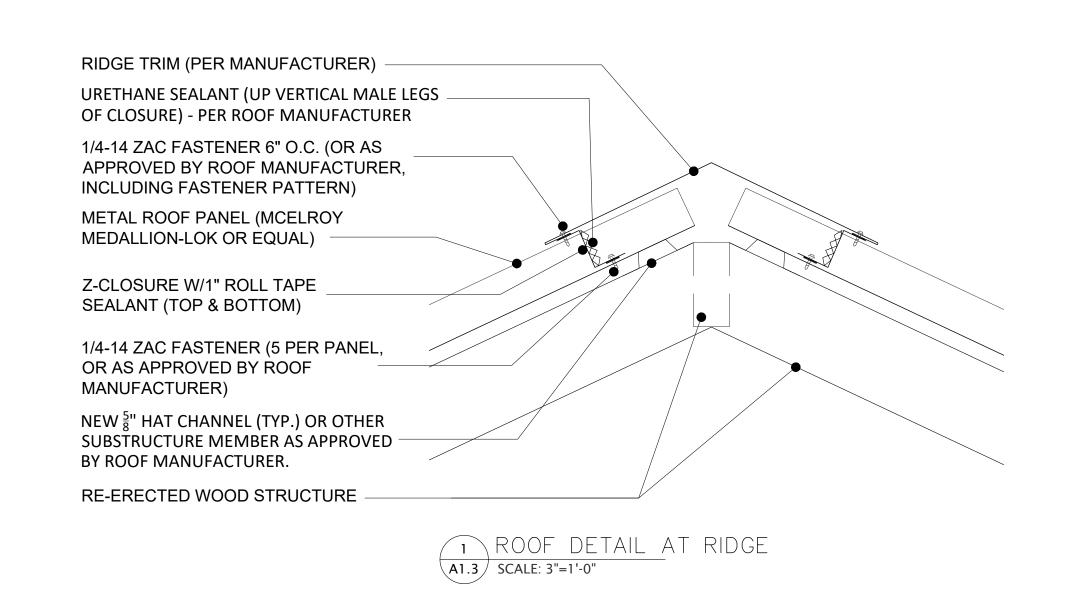
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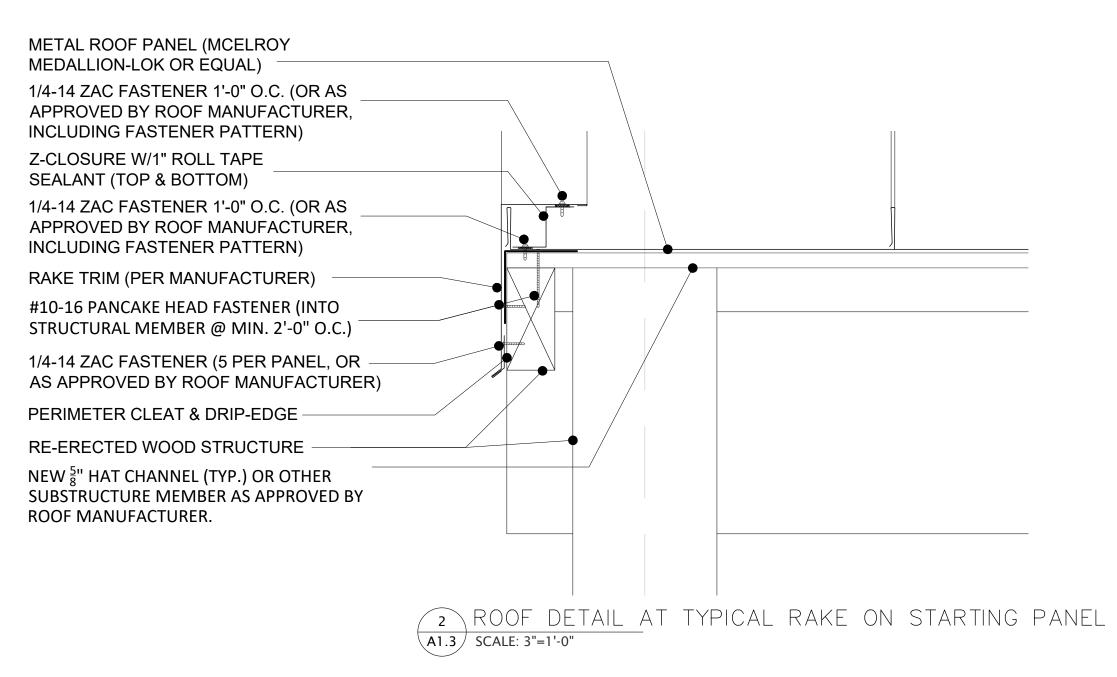
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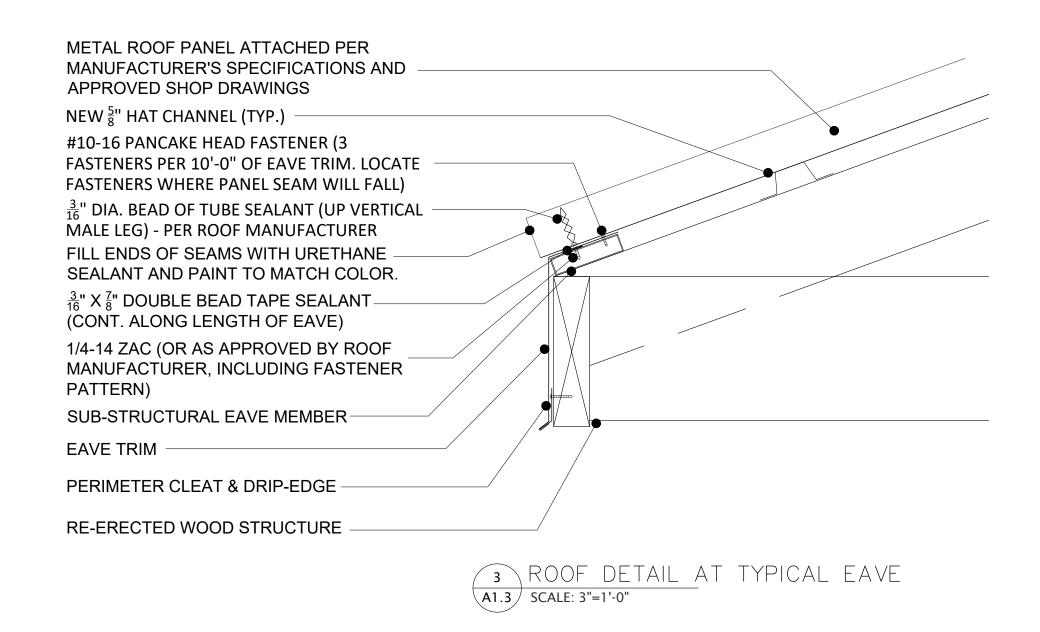
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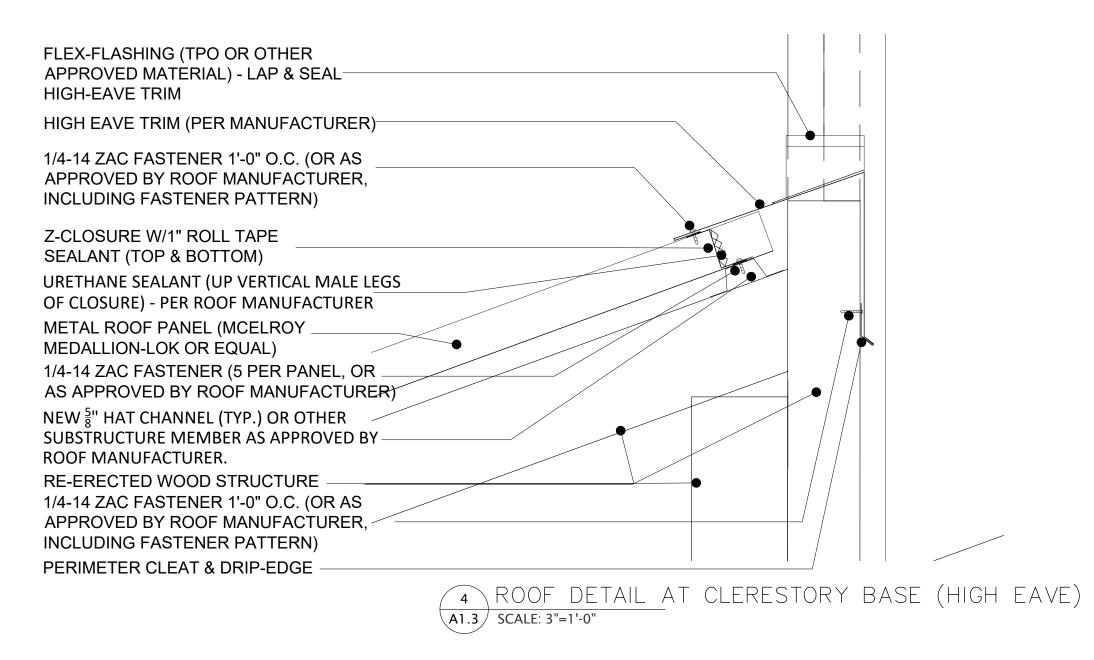
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RP17802R









DYPSKI PARK SITE IMPROVEMENTS

1225 S. Ellwood Ave, Baltimore, MD 21223

Block 1898 Lot 19A CITY OF BALTIMORE
DEPARTMENT OF RECREATION AND PARKS
TR.
DE
PAVILION ERECTION
ROOF DETAILS
PI

DATE September 30, 2020

SCALE see drawing scale

DRAWN BY L. DECKER
TRACED BY
DESIGNED BY
CHECKED BY
PROJECT NO. SHEET NO.
RP17802R A1.3r

